
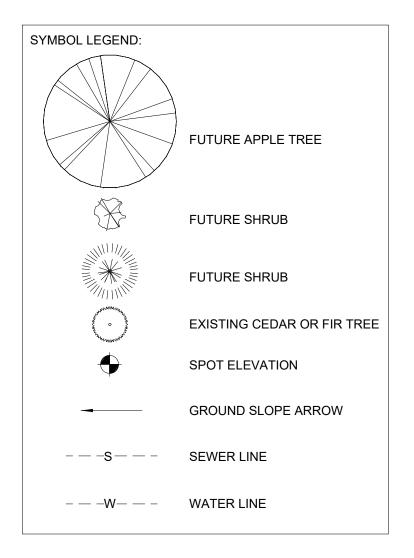


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ZONING NOTES:

- CIVIC ADDRESS: 732 GRANDVIEW TERRACE LEGAL DESCRIPTION: PL 7569 LT 8 SEC 6 TWP
- 20 RGE 17 MER 6 CURRENT ZONING: RT-1
- LOT AREA: 10005.78 SF
- BUILDING AREA: 2053.82 SF
- LOT COVERAGE: 21%
- MAX. LOT COVERAGE: 40%
- MIN. PARKING REQUIRED: 3 STALLS
- PARKING PROVIDED: 4 STALLS

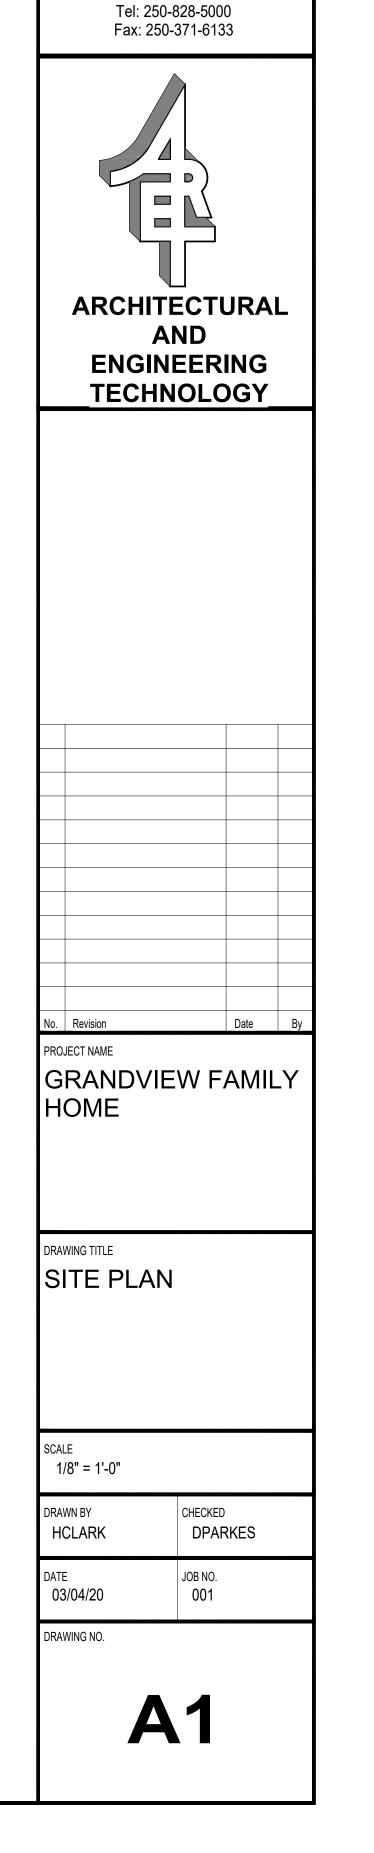

THOMPSON

RIVERS


UNIVERSITY


900 McGill Road

Box 3010

Kamloops, BC

V2C 0C8

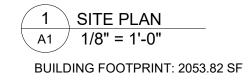

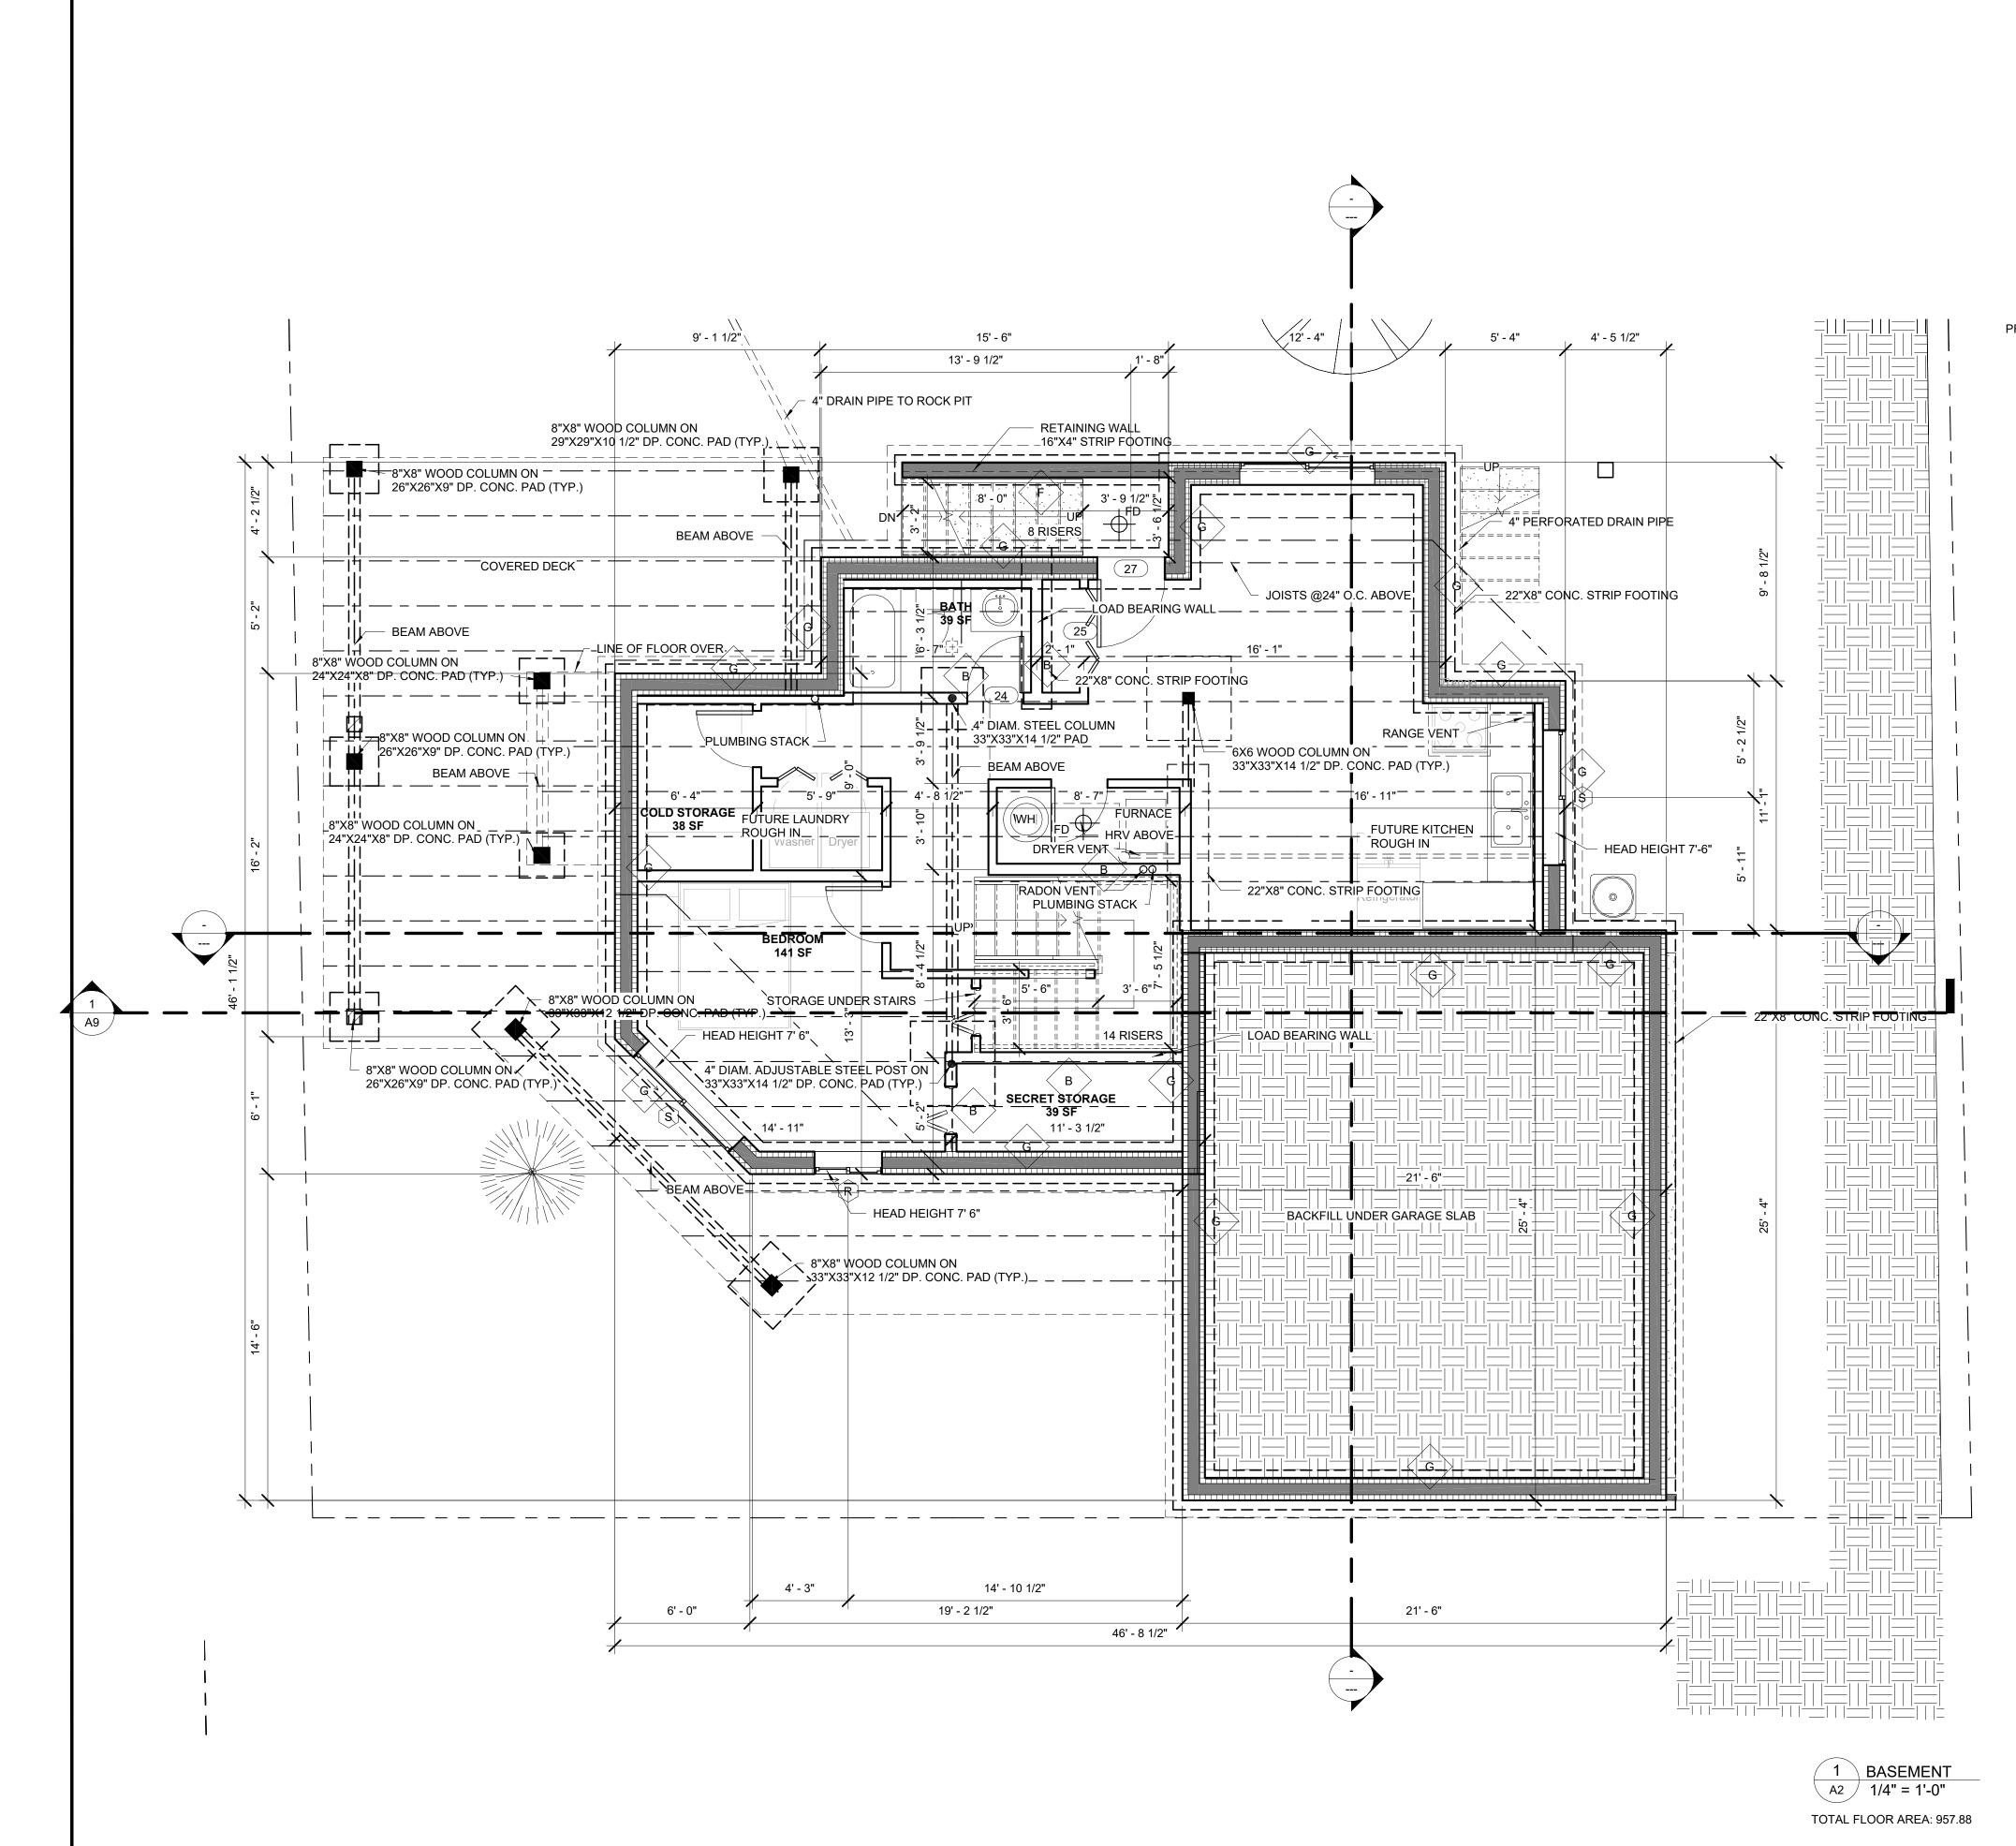

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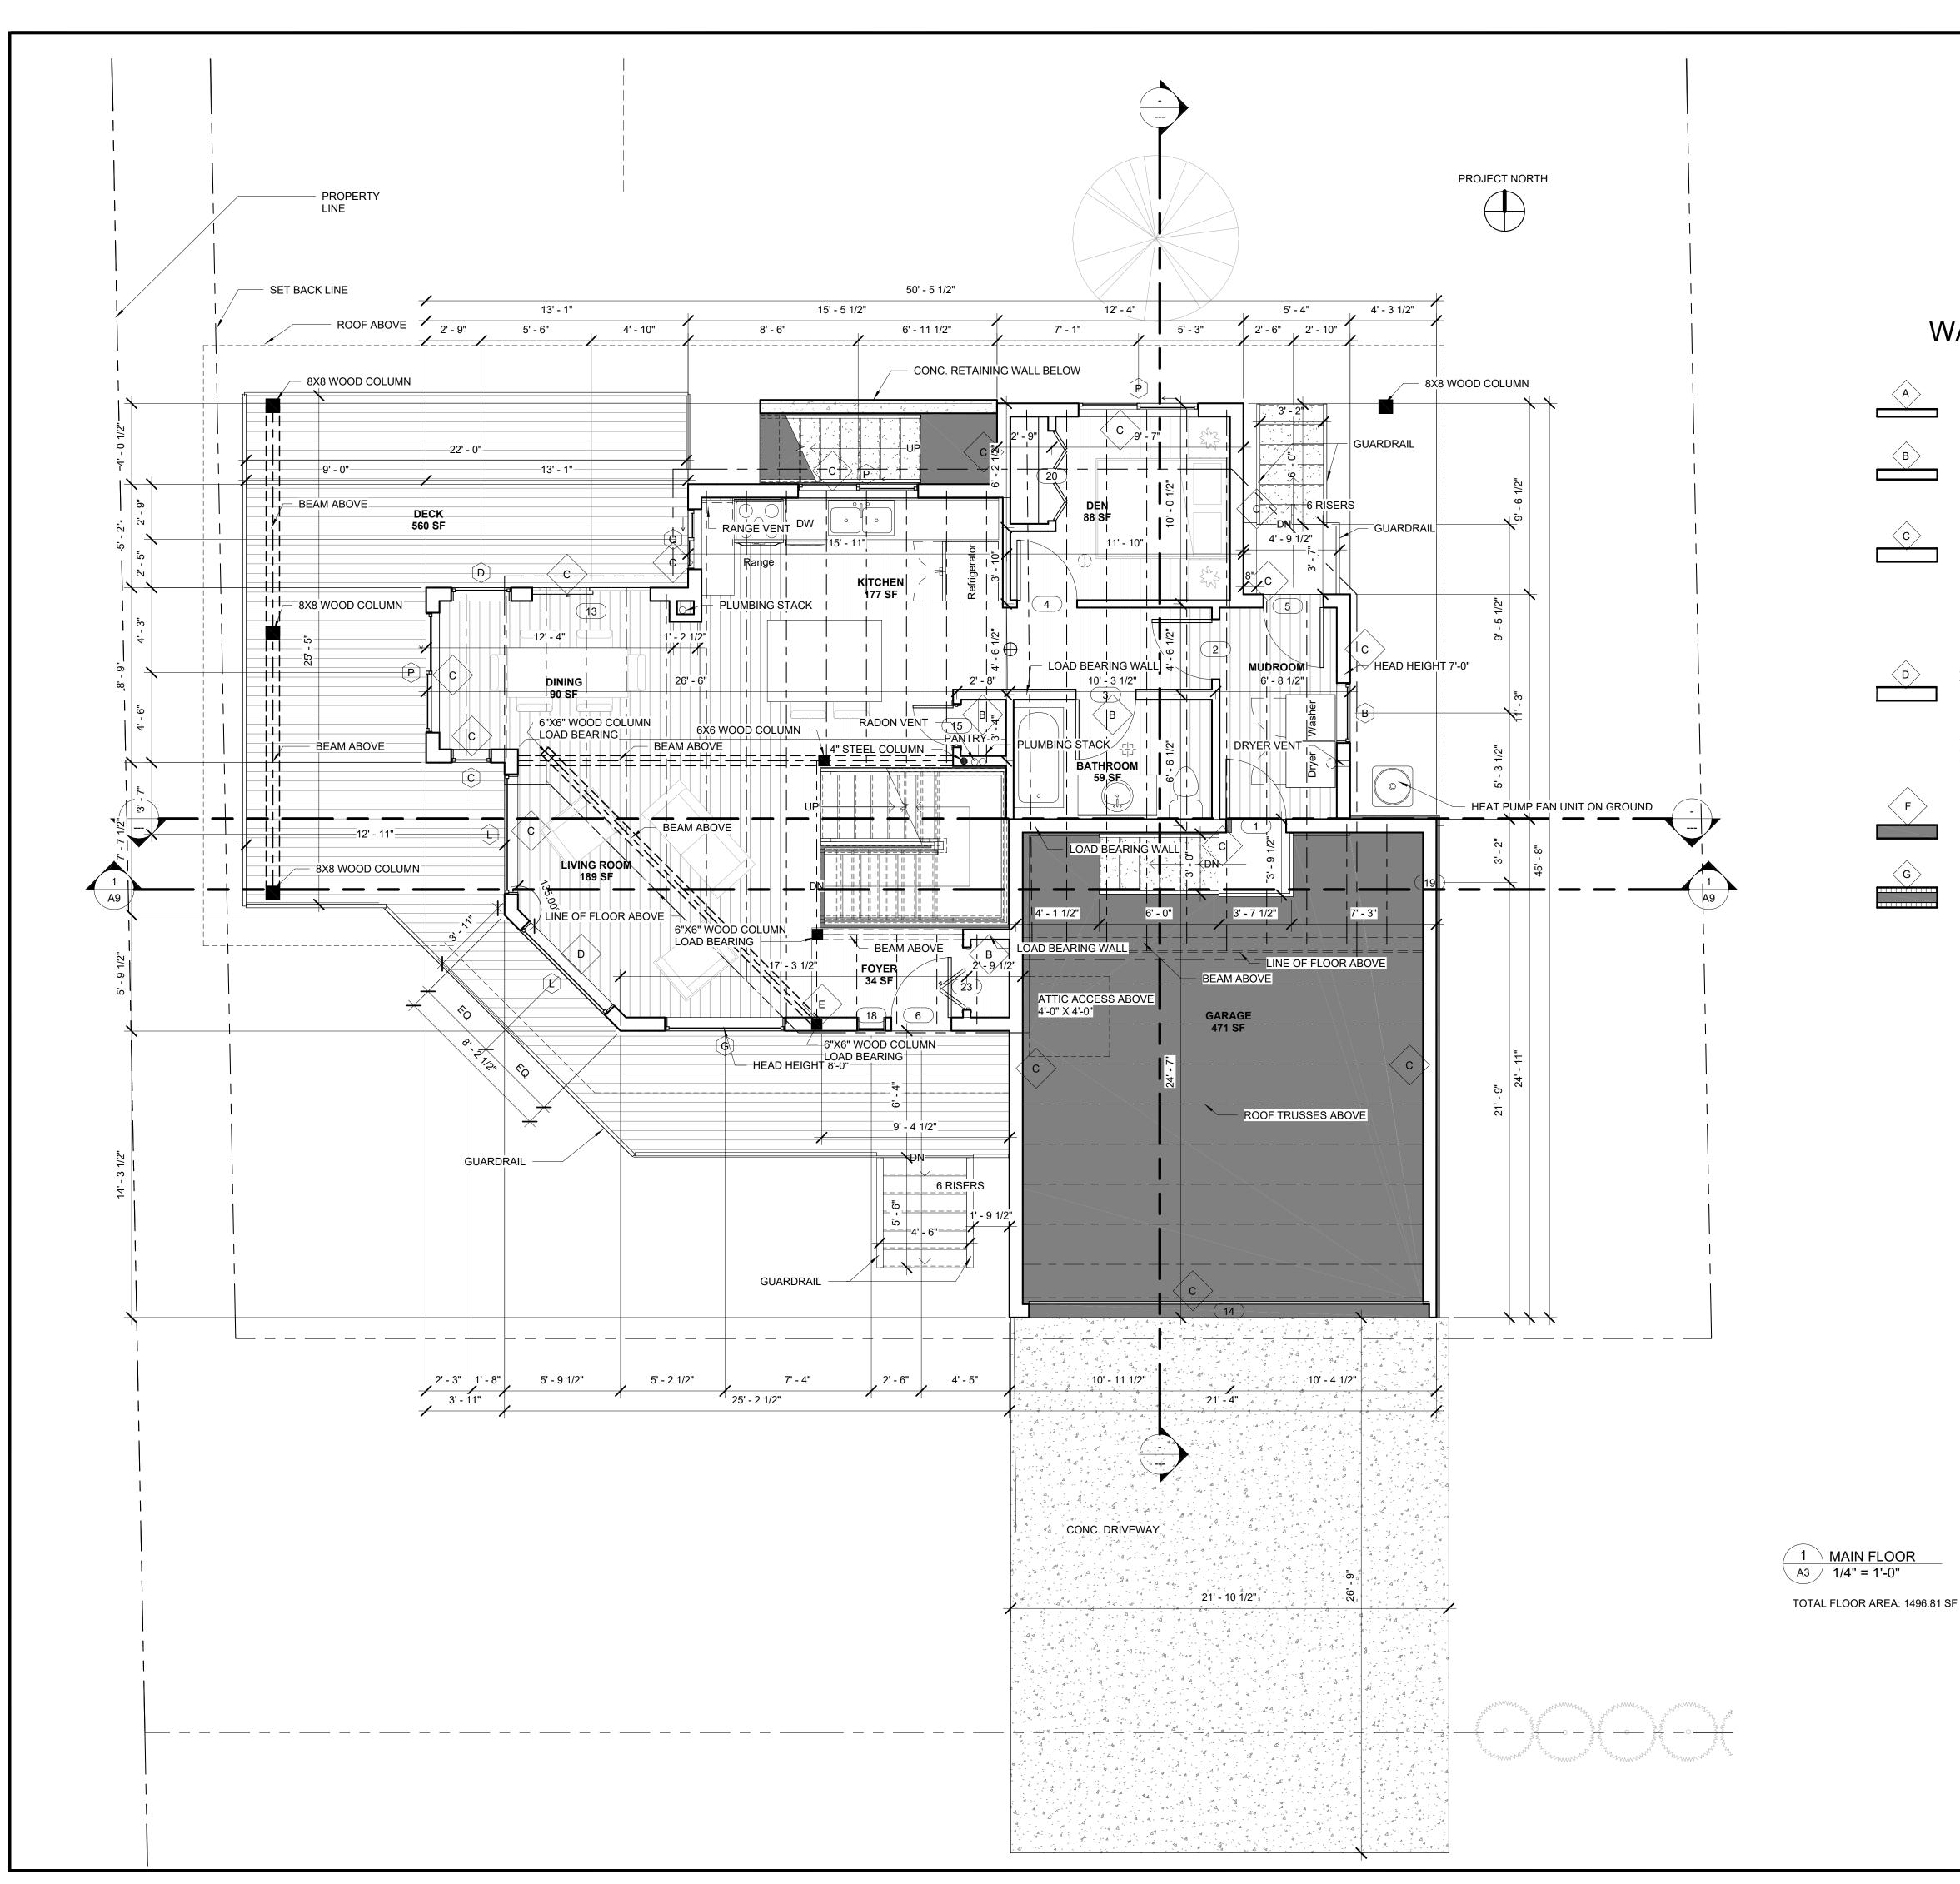
DOOR SCHEDULE								
DOOR								
NUMBER	WIDTH	HEIGHT	ТҮРЕ	COMMENTS				
1	3' - 0"	6' - 8"	Single-Flush					
2	3' - 0"	6' - 8"	Single-Flush					
3	3' - 0"	6' - 8"	Single-Flush					
4	3' - 0"	6' - 8"	Single-Flush					
5	3' - 0"	7' - 0"	Single-Flush					
6	3' - 0"	7' - 0"	Single-Flush					
7	2' - 6"	6' - 8"	Single-Flush					
8	2' - 6"	6' - 8"	Single-Flush					
9	2' - 6"	6' - 8"	Single-Flush					
11	2' - 6"	6' - 8"	Single-Flush					
12	2' - 6"	6' - 8"	Single-Flush					
13	5' - 11"	6' - 10 1/2"	M_Door-Double-Sliding					
14	20' - 0"	10' - 0"	M_Door-Overhead-Sectional					
15	2' - 0"	6' - 6 1/2"	M_Door-Interior-Single-1_Panel-Woo d					
16	2' - 6"	6' - 8"	Single-Flush					
17	2' - 6"	6' - 8"	Single-Flush					
18	1' - 3"	6' - 10 1/2"	M_Door-Exterior-Side_Lite-Full Flat Glass-Wood_Clad					
19	3' - 0"	7' - 0"	Single-Flush					
20	4' - 6"	7' - 0"	Bifold_four_panel_door_2_panel_wit h_arch_top_3371 (1)					
22	4' - 6"	7' - 0"	Bifold_four_panel_door_2_panel_wit h_arch_top_3371 (1)					
23	3' - 0"	7' - 0"	2_Panel_Bifold_Door_18618 (1)					
24	2' - 6"	6' - 8"	Single-Flush					
25	4' - 0"	6' - 8"	Bifold_four_panel_door_2_panel_wit h_arch_top_3371 (1)					
27	3' - 0"	7' - 0"	Single-Flush					
32	2' - 6"	6' - 8"	Single-Flush					
33	2' - 0"	7' - 0"	2_Panel_Bifold_Door_18618 (1)					
34	4' - 0"	6' - 8"	Bifold_four_panel_door_2_panel_wit h_arch_top_3371 (1)					
36	2' - 0"	7' - 0"	2_Panel_Bifold_Door_18618 (1)					
37	2' - 6"	6' - 8"	Single-Flush					
38	2' - 6"	6' - 8"	Single-Flush					
39	2' - 6"	6' - 8"	Single-Flush					
40	4' - 0"	6' - 8"	Bifold_four_panel_door_2_panel_wit h_arch_top_3371 (1)					

PROJECT NORTH

SYMBOL LEGEND:

- Image: Constraint of the second sec
- 101 DOOR TAG
- 1i WALL TAG
- (1t) WINDOW TAG

Image: constraint of the constra				
ARCHITECTURAL AND ENGINEERING TECHNOLOGY				
No. Revision PROJECT NAME GRANDVIE HOME	Date By			
DRAWING TITLE BASEMENT FLOOR PLAN				
SCALE 1/4" = 1'-0"				
DRAWN BY HCLARK	CHECKED DPARKES			
DATE 03/23/20	JOB NO. 001			
DRAWING NO.	2			



WALL SCHEDULE

 $\langle A \rangle$

 $\langle \mathsf{B} \rangle$

 $\langle c \rangle$

 $\langle \mathsf{D} \rangle$

 $\langle F \rangle$

 $\langle G \rangle$

TYPE A: 4 1/2" WOOD FRAME PARTITION WALL 1/2" GWB 2"X4" STUDS @ 24" O.C. 1/2" GWB

TYPE B: 6" WOOD FRAME PLUMBING/ LOAD BEARING WALL 1/2" GWB 2"X6" STUDS @ 24" O.C.

1/2" GWB TYPE C: 8" DOUBLE STUD EXTERIOR WALL VERTICAL BOARD AND BATTON SIDING

1/2" FURRING STRIPS MOISTURE BARRIER (BUILDING PAPER) 1/2" OSB SHEATHING 8" SPRAY APPLIED CELLULOSE INSUL. BETWEEN STUDS 2"X8" TOP AND BOTTOM PLATES 2"X4" STUDS @ 24" O.C., OFFSET ON 6 MIL POLY VAPOUR BARRIER 1/2" GWB ON INTERIOR


TYPE D: 8" DOUBLE STUD EXTERIOR WALL STONE VENEER MOISTURE BARRIER (2 LAYERS OF BUILDING PAPER) 1/2" OSB SHEATHING 8" SPRAY APPLIED CELLULOSE INSUL. BETWEEN STUDS 2"X8" TOP AND BOTTOM PLATES 2"X4" STUDS @ 24" O.C., OFFSET ON 6 MIL POLY VAPOUR BARRIER 1/2" GWB ON INTERIOR

TYPE F: EXTERIOR RETAINING WALL 8" CAST IN PLACE CONCRETE WALL

TYPE G: INSULATED CONCRETE FORM WALL BELOW GRADE: WATER PROOF MEMBRANE OR DRAIN MAT ON EXTERIOR ABOVE GRADE: STUCCO PARGING ON WIRE LATH MOISTURE BARRIER (2 LAYERS OF BUILDING PAPER)

3" ICF PANEL **6" CONCRETE CORE** 3" ICF PANEL 1/2" GWB ON INTERIOR MECHANICALLY FASTENED TO ICF WEBS (NO GLUE)


THOMPSON **RIVERS** UNIVERSITY 900 McGill Road Box 3010 Kamloops, BC V2C 0C8 Tel: 250-828-5000 Fax: 250-371-6133 ARCHITECTURAL AND ENGINEERING TECHNOLOGY Date lo. Revision PROJECT NAME **GRANDVIEW FAMILY** HOME DRAWING TITLE MAIN FLOOR PLAN SCALE 1/4" = 1'-0" CHECKED DRAWN BY HCLARK DPARKES JOB NO. DATE 03/23/20 001 DRAWING NO. **A3**

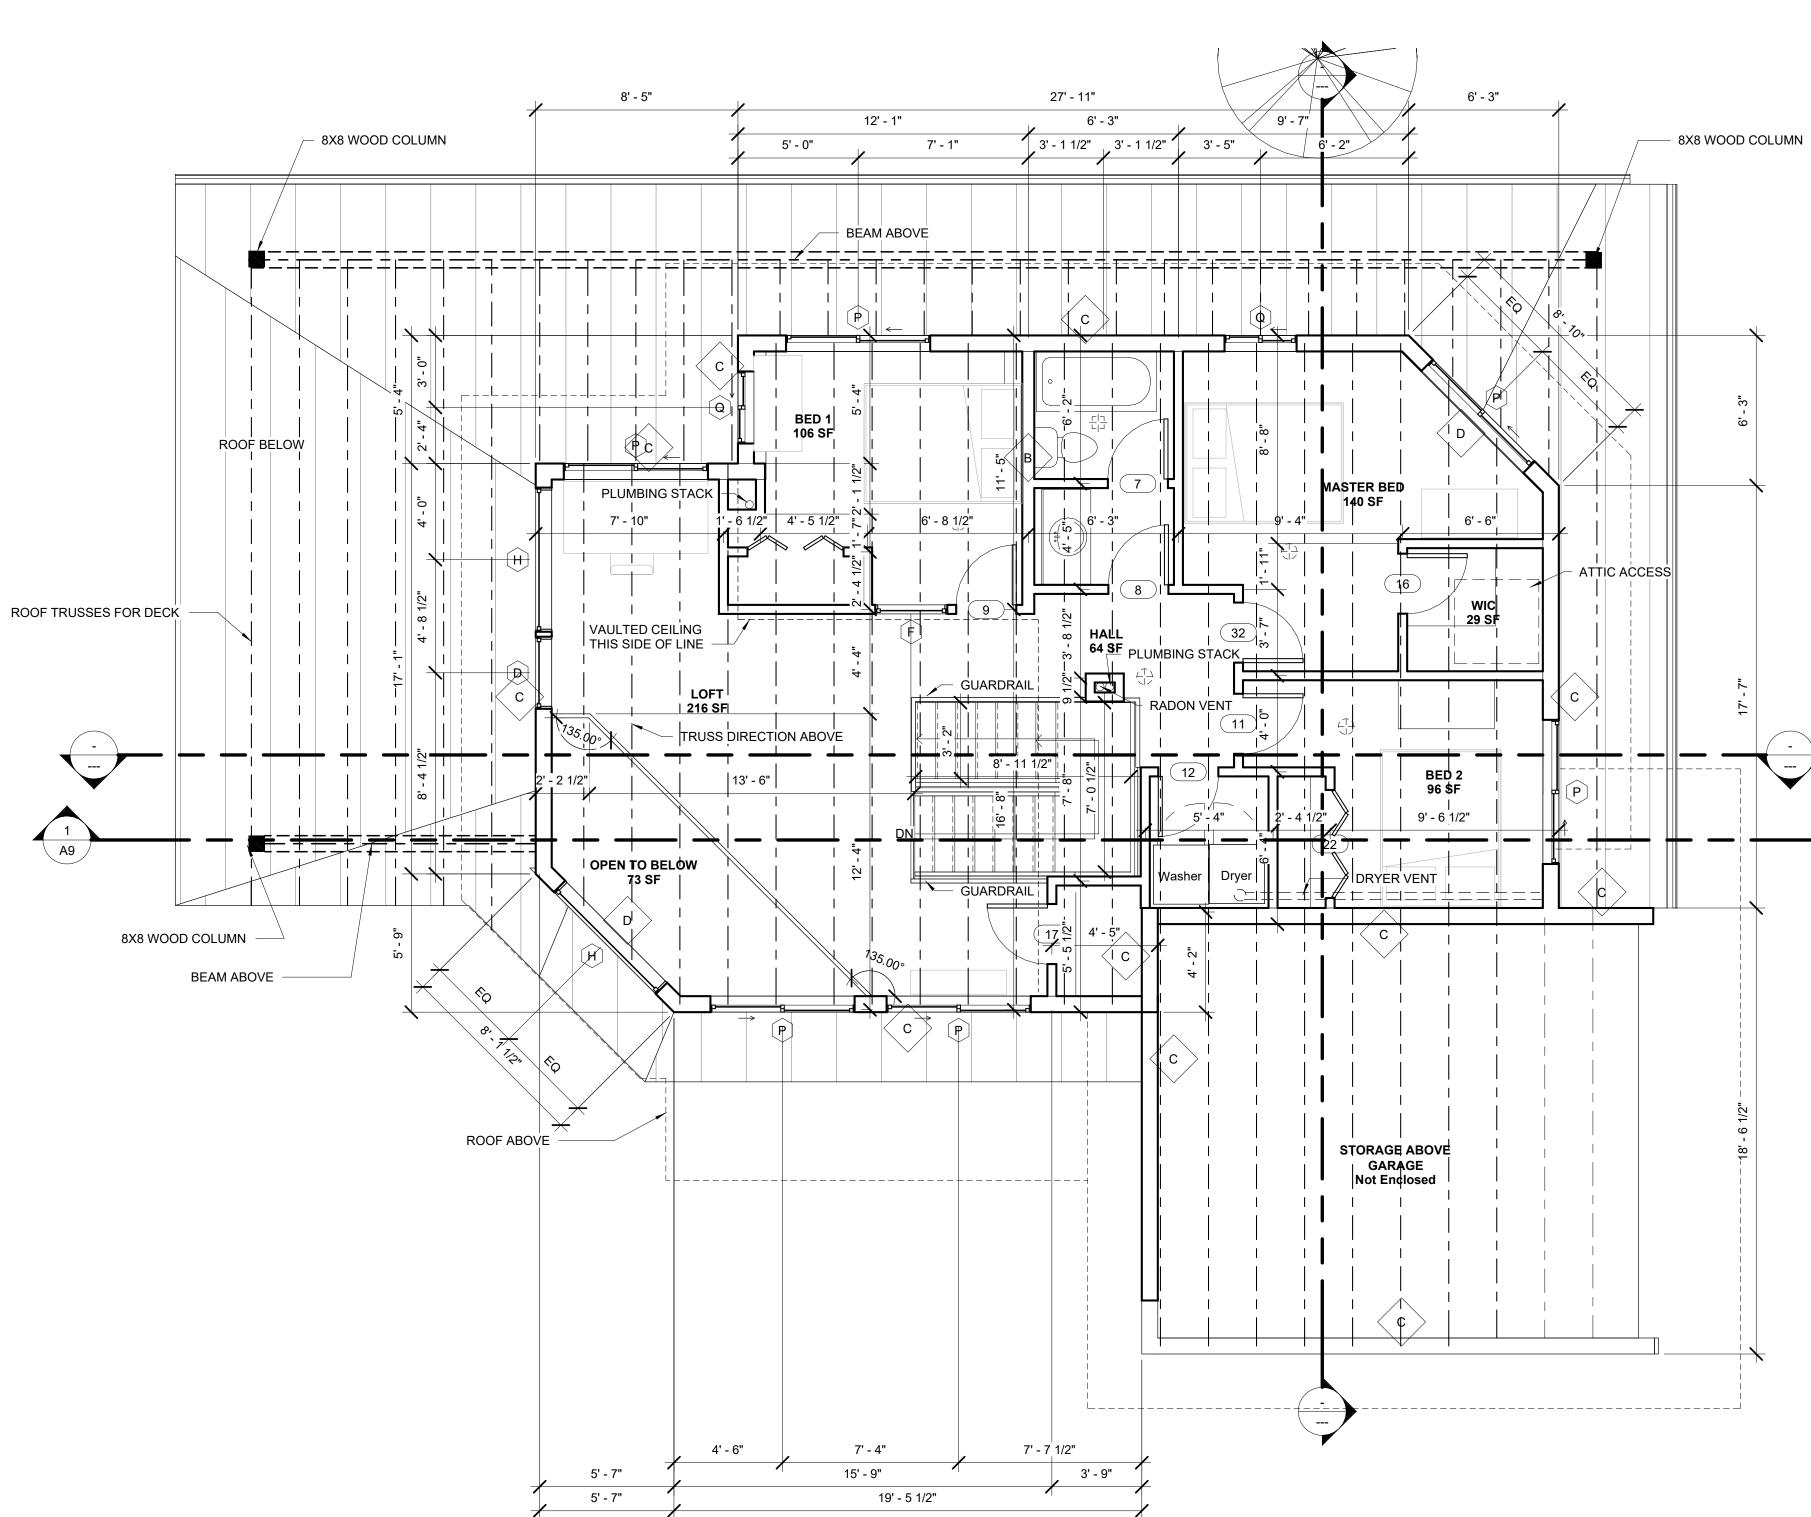

				WINDC	W SCHEDUL	E
TYPE	QTY	WIDTH	HEIGHT	HEAD HEIGHT	STYLE	COMMENTS
В	1	3' - 0"	2' - 0"	15' - 0"	Fixed	HEAD HEIGHT 7'-6" UNLESS NOTED ON PLAN
С	1	2' - 0"	4' - 0"	7' - 3"	Fixed	
D	2	3' - 0"	4' - 0"		Fixed	HEAD HEIGHT 7'-6" ON BASEMENT; 7'-0" ON MAIN FLOOR; 60" ON UPPER FLOOR
F	1	3' - 0"	8"	6' - 8"	Fixed	
G	1	6' - 0"	2' - 0"	7' - 3"	Fixed	HEAD HEIGHT 7'-6" UNLESS NOTED ON PLAN
Н	2	6' - 0"	4' - 0"	6' - 6"	Fixed	HEAD HEIGHT 7'-6" ON BASEMENT; 7'-0" ON MAIN FLOOR; 60" ON UPPER FLOOR
J	1	2' - 0"	1' - 4"	5' - 10"	Fixed	
L	2	6' - 0"	5' - 0"	7' - 3"	Fixeu	
Ρ	9	6' - 0"	4' - 0"			HEAD HEIGHT 7'-6" ON BASEMENT; 7'-0" ON MAIN FLOOR; 60" ON UPPER FLOOR
Q	3	3' - 0"	4' - 0"			HEAD HEIGHT 7'-6" ON BASEMENT; 7'-0" ON MAIN FLOOR; 60" ON UPPER FLOOR
R	1	3' - 0"	2' - 0"	7' - 6"	M ^{VARIES} ow- Sliding-Dou VARIES ble	HEAD HEIGHT 7'-6" UNLESS NOTED ON PLAN
S	3	6' - 0"	2' - 0"	7' - 6"	M_Window- Sliding-Dou ble	







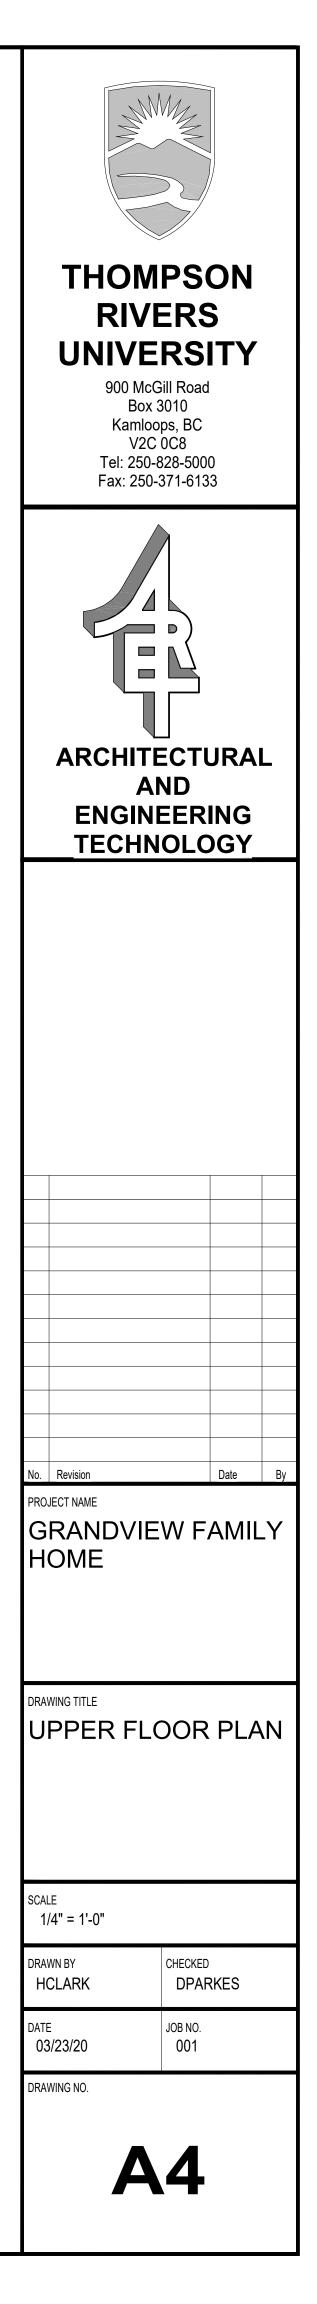


1 UPPER FLOOR A4 1/4" = 1'-0" TOTAL FLOOR AREA: 968.61 SF



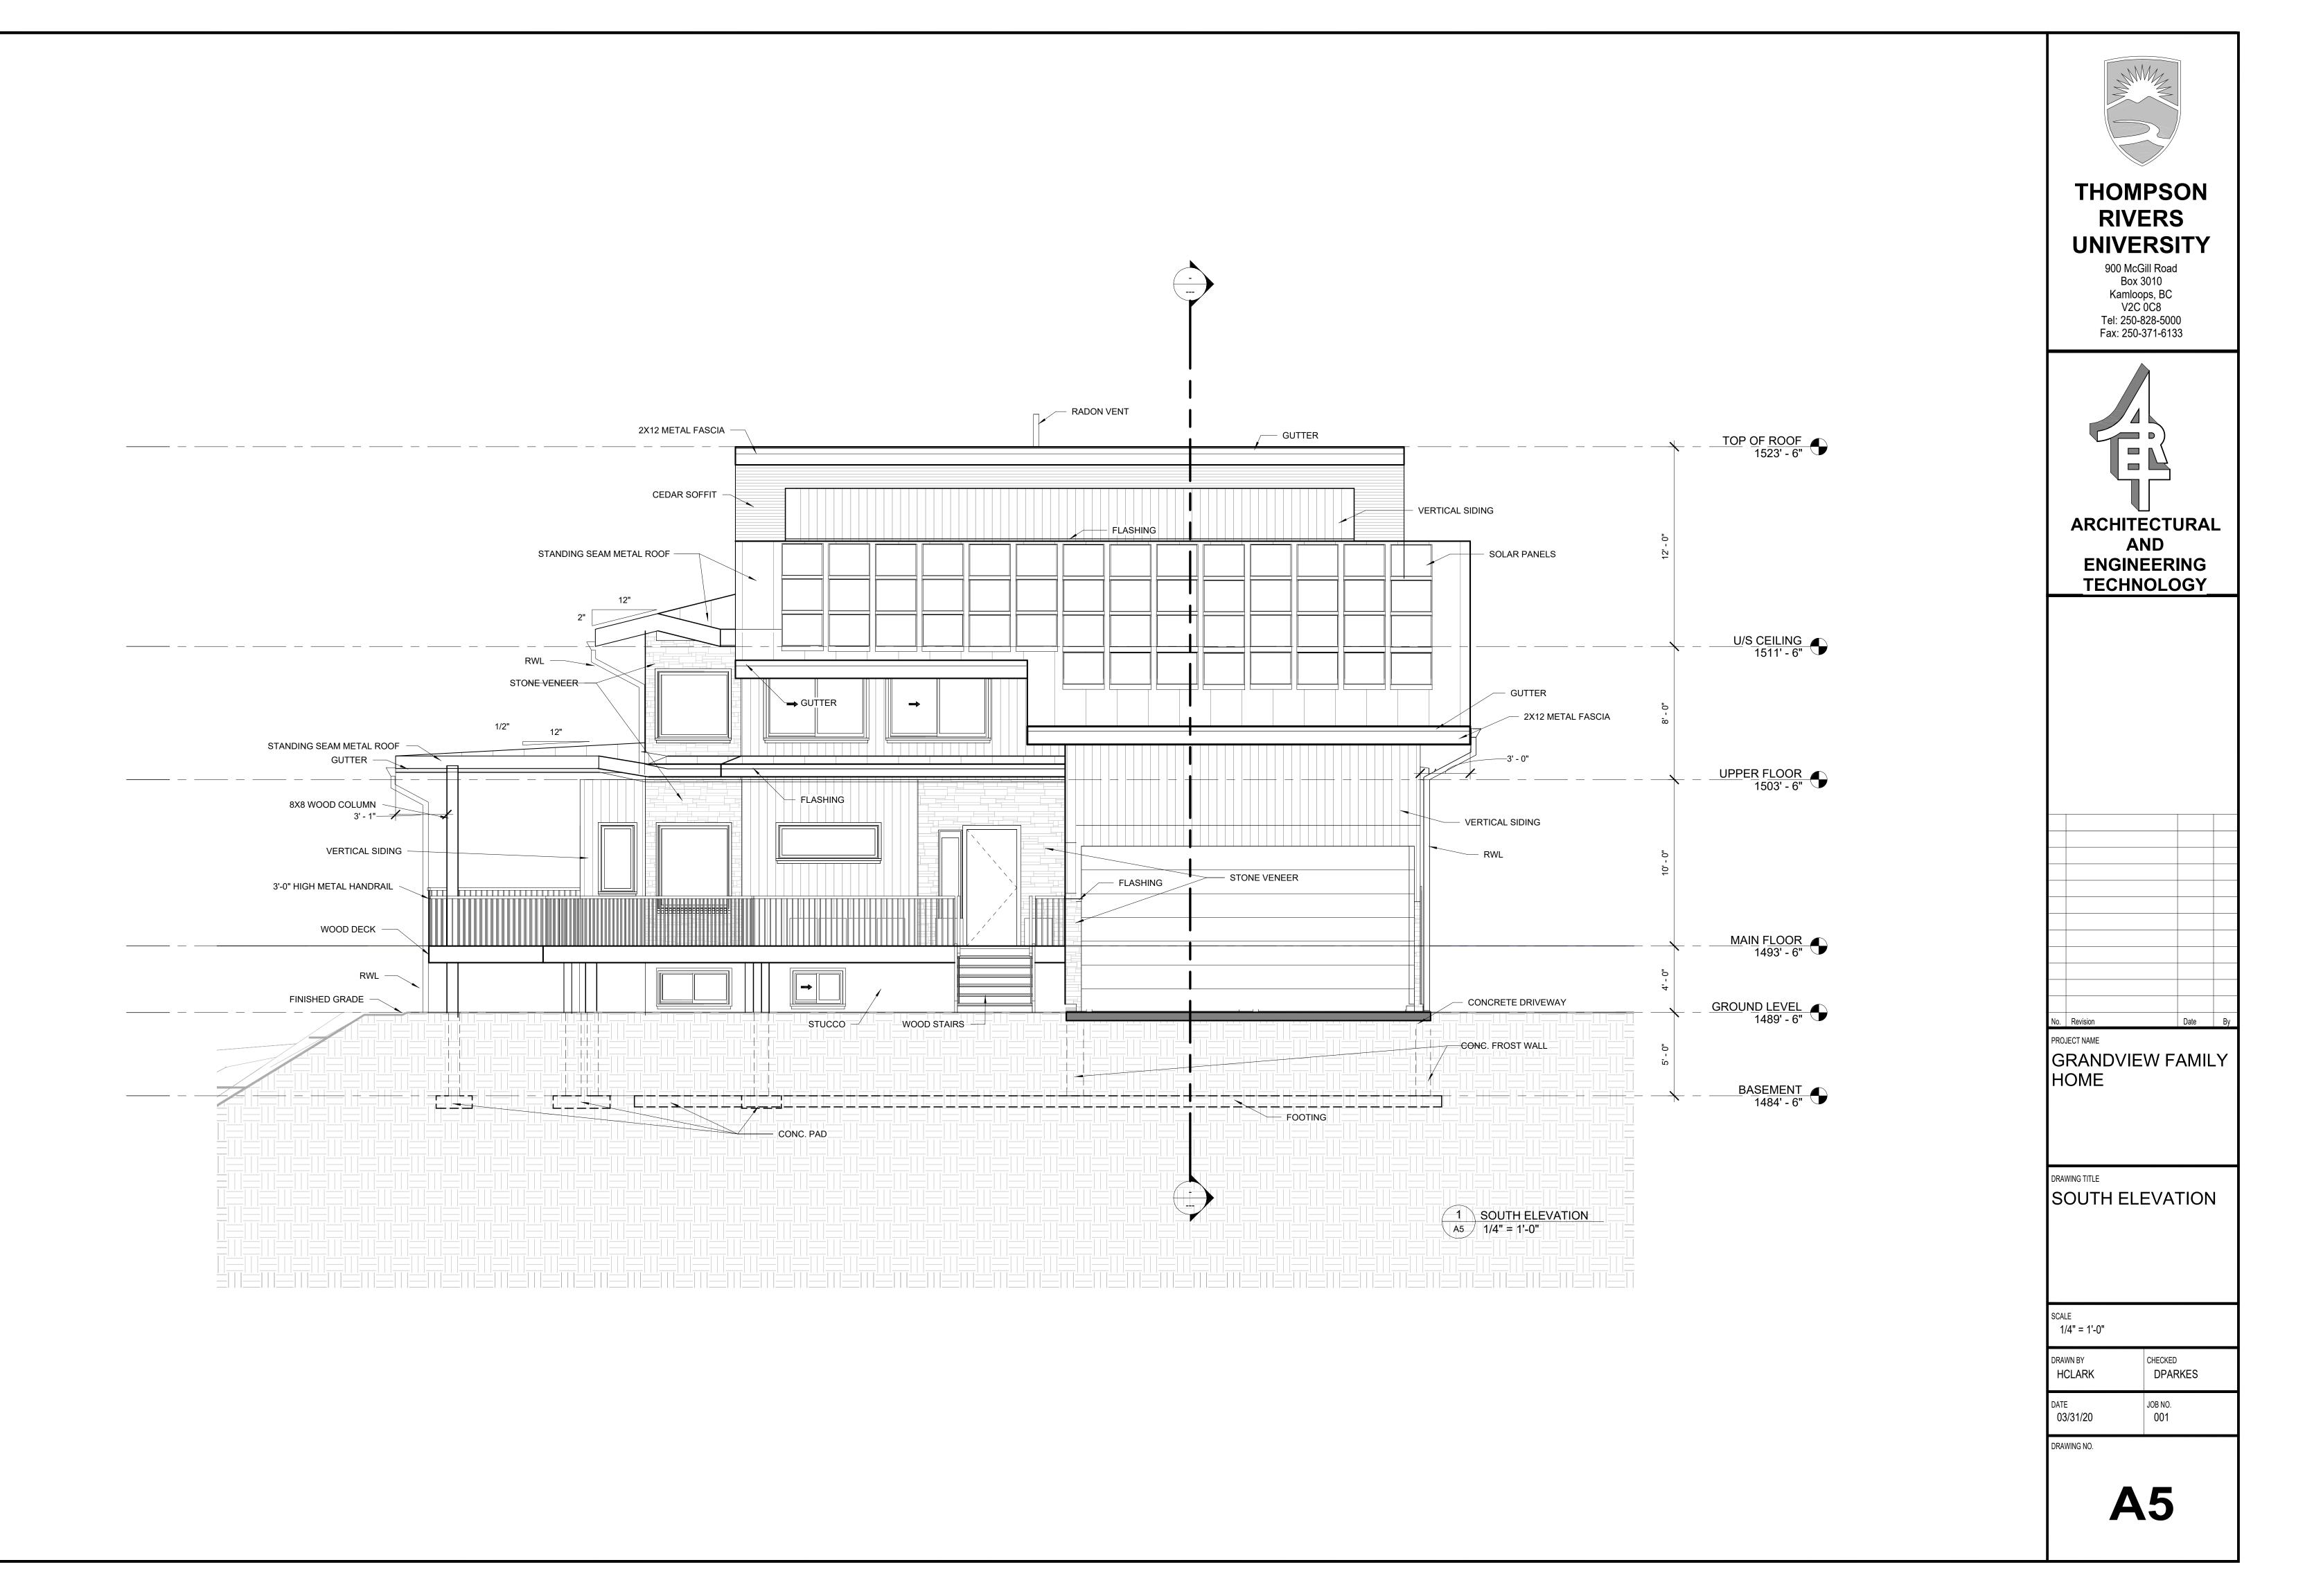

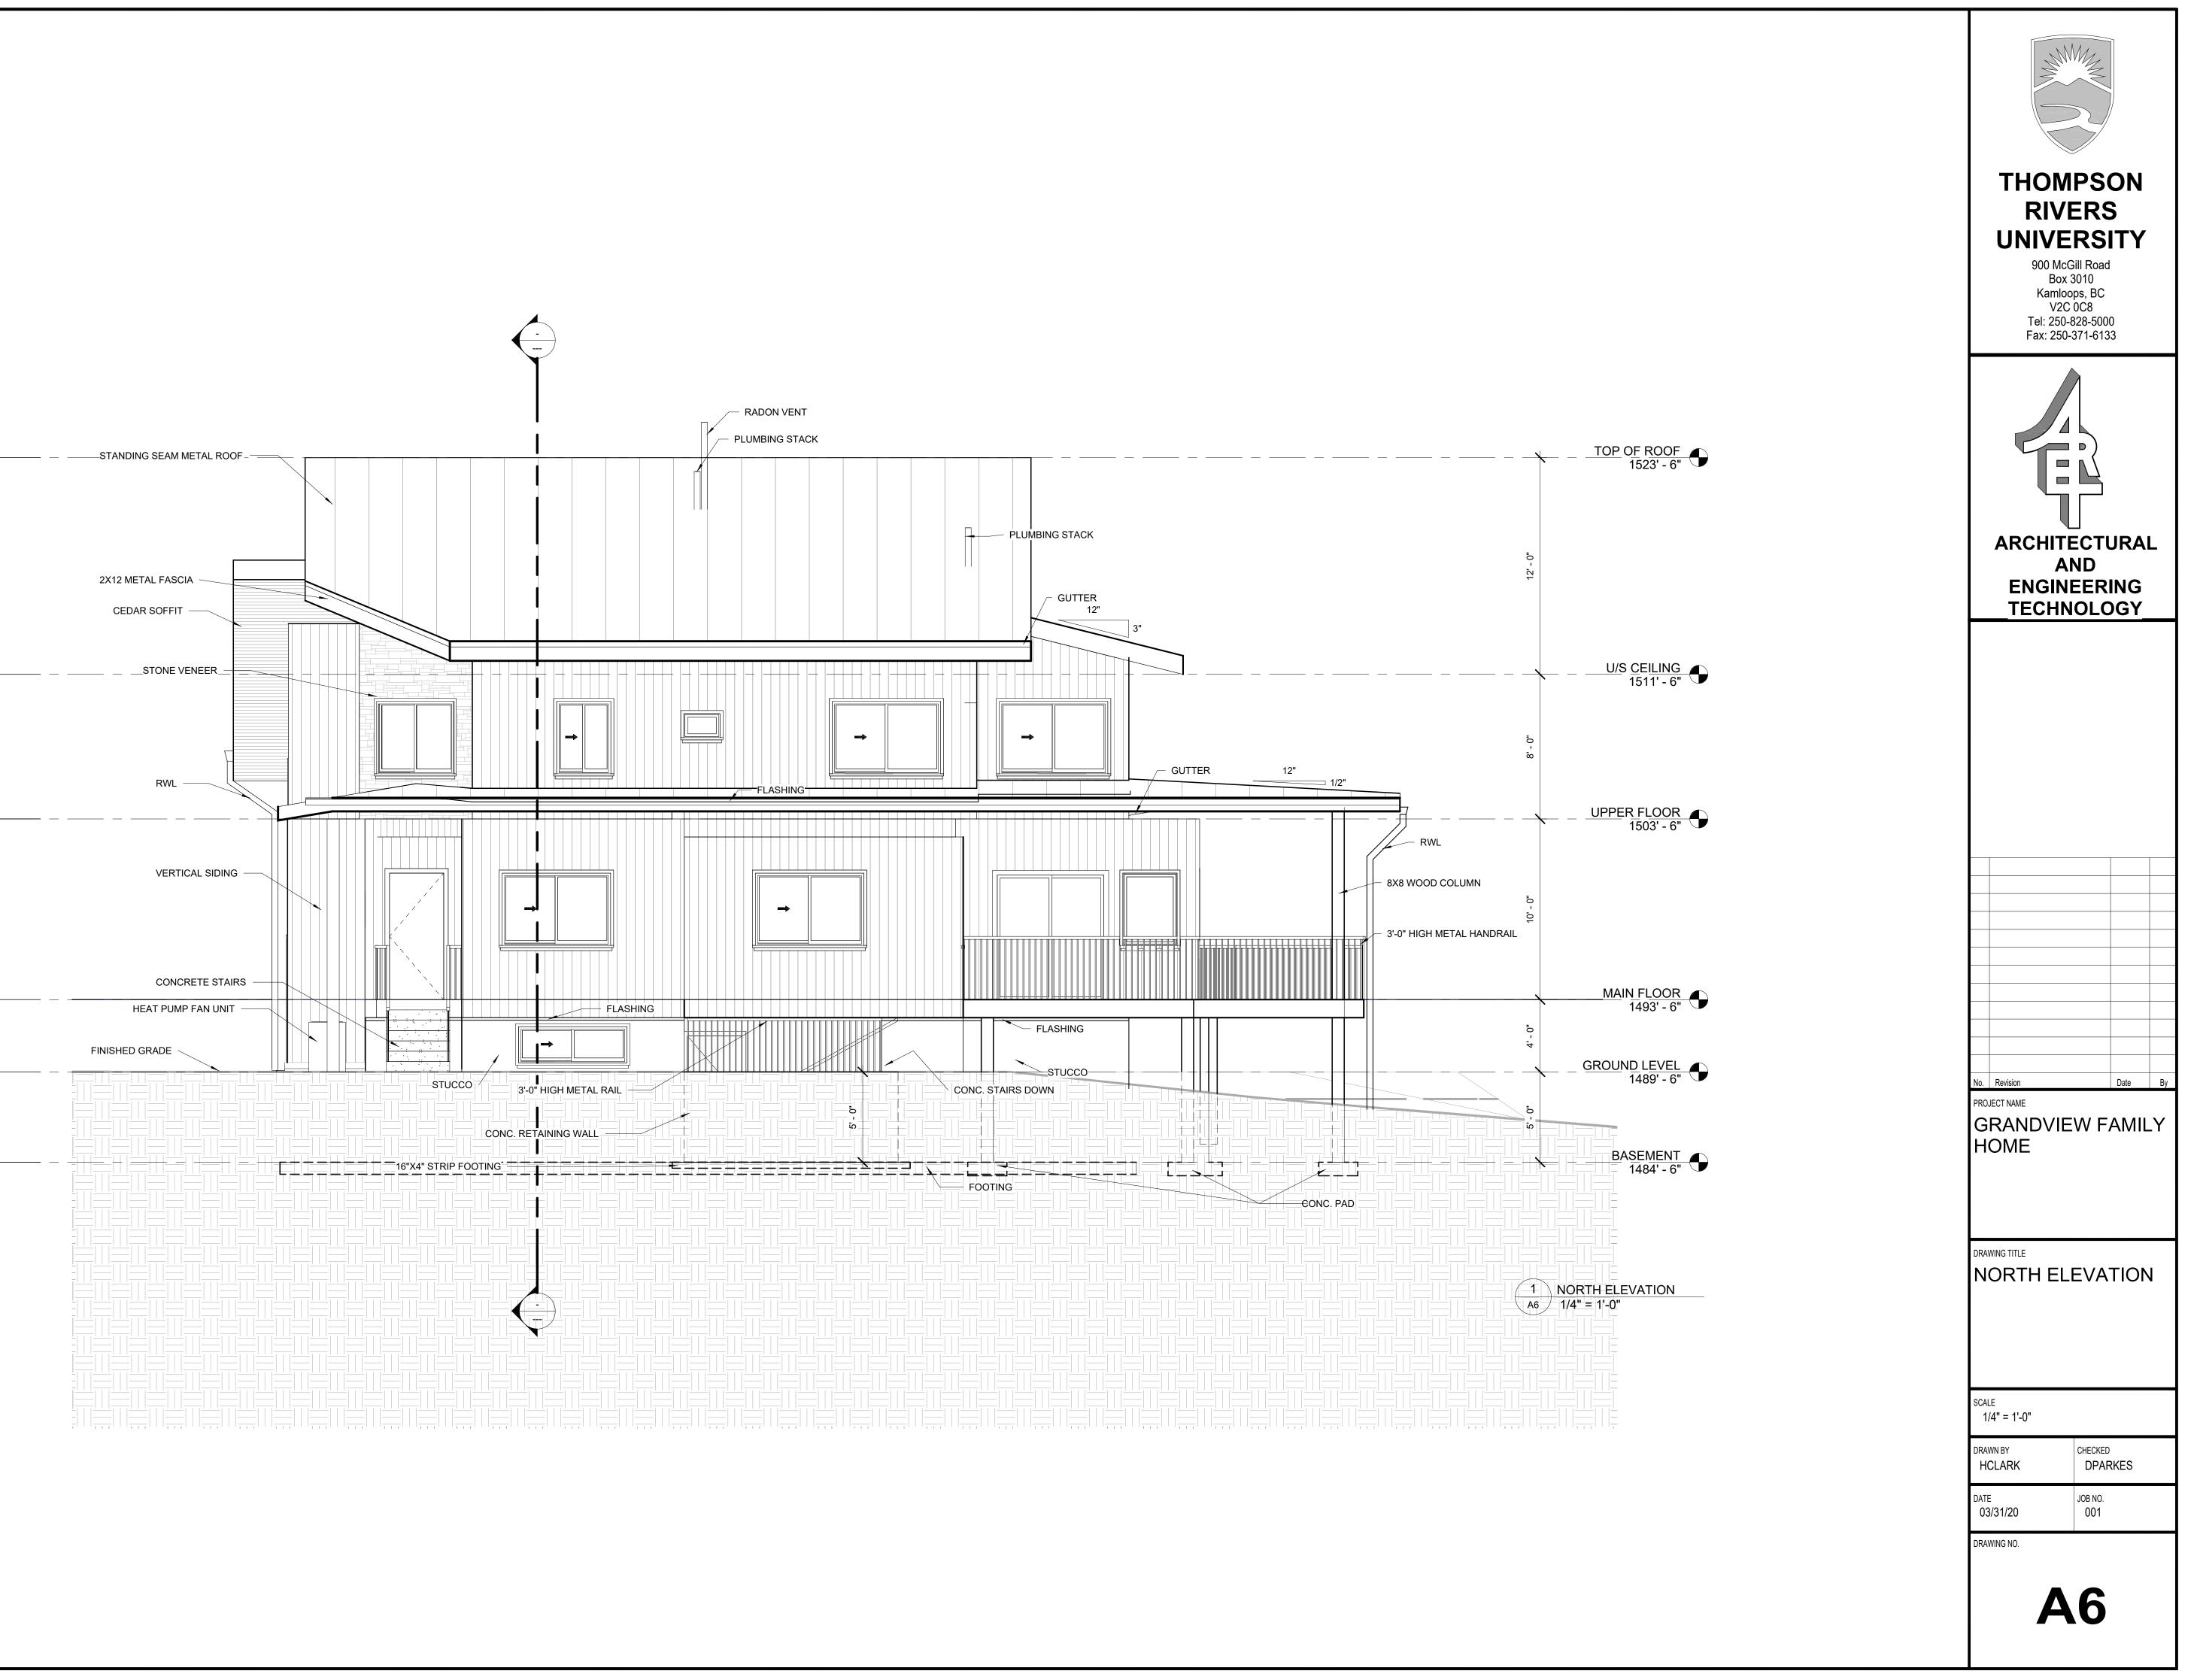

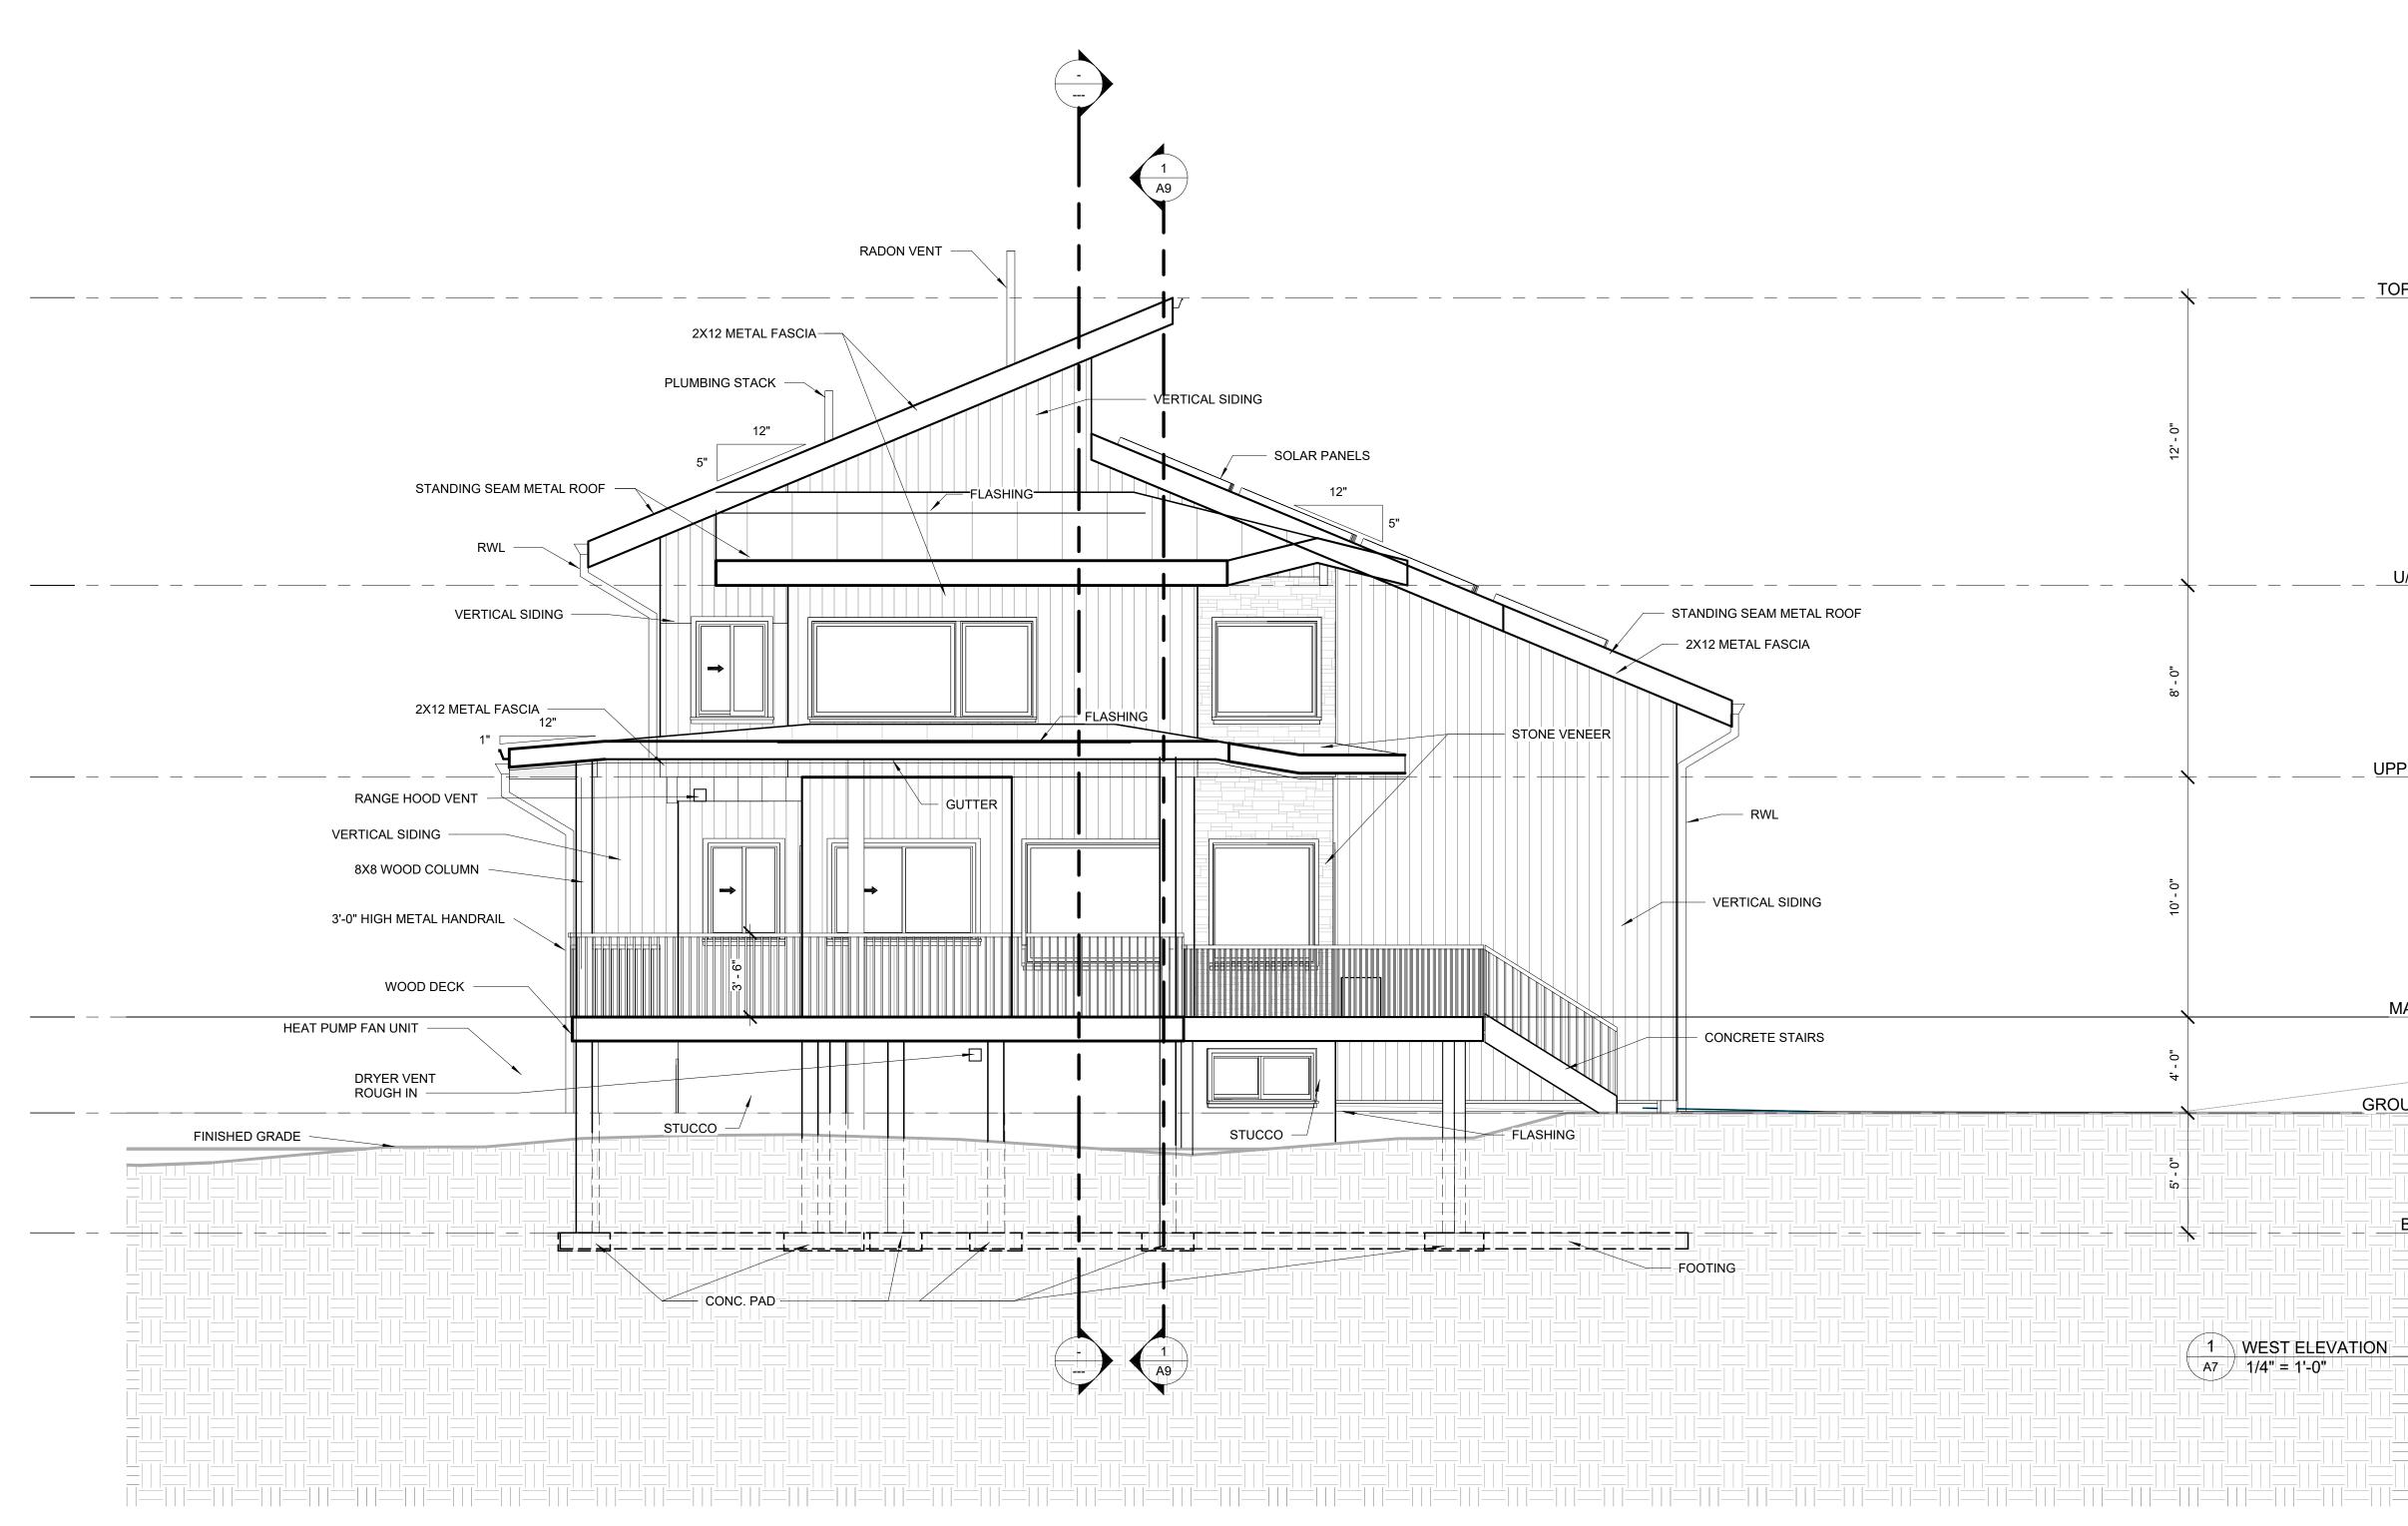

EXTERIOR FINISH SCHEDULE

COLOUR: BENJAMIN MOORE-NEW YORK STATE OF MIND

STUCCO: SYNTHETIC FINISH

COLOUR: BENJAMIN MOORE-STONINGTON GREY

ROOFING: STANDING SEAM GALVANIZED STEEL ROOF COLOUR: MATTE BLACK

DOORS: FIBERGLASS COLOUR: CASHMERE

WINDOWFRAMES: FIBERGLASS COLOUR: CASHMERE

FASCIA AND EAVESTROUGHS: PAINTED ALUMINUM COLOUR: CHARCOAL


SOFFIT: CEDAR SOFFIT, VENTED COLOUR: DARK WALNUT STAIN


FLASHING: PREPAINTED GALVANIZED STEEL COLOUR: CHARCOAL


SIDING: VERTICAL BOARD AND BATTON SIDING


STONE VENEER: VERSETTA STONE LEDGESTONE STYLE VENEER COLOUR: STERLING

NOTE: FLASHING, AS REQUIRED BY CODE, TO BE PROVIDED ABOVE AND BELOW ALL WINDOWS AND DOORS.

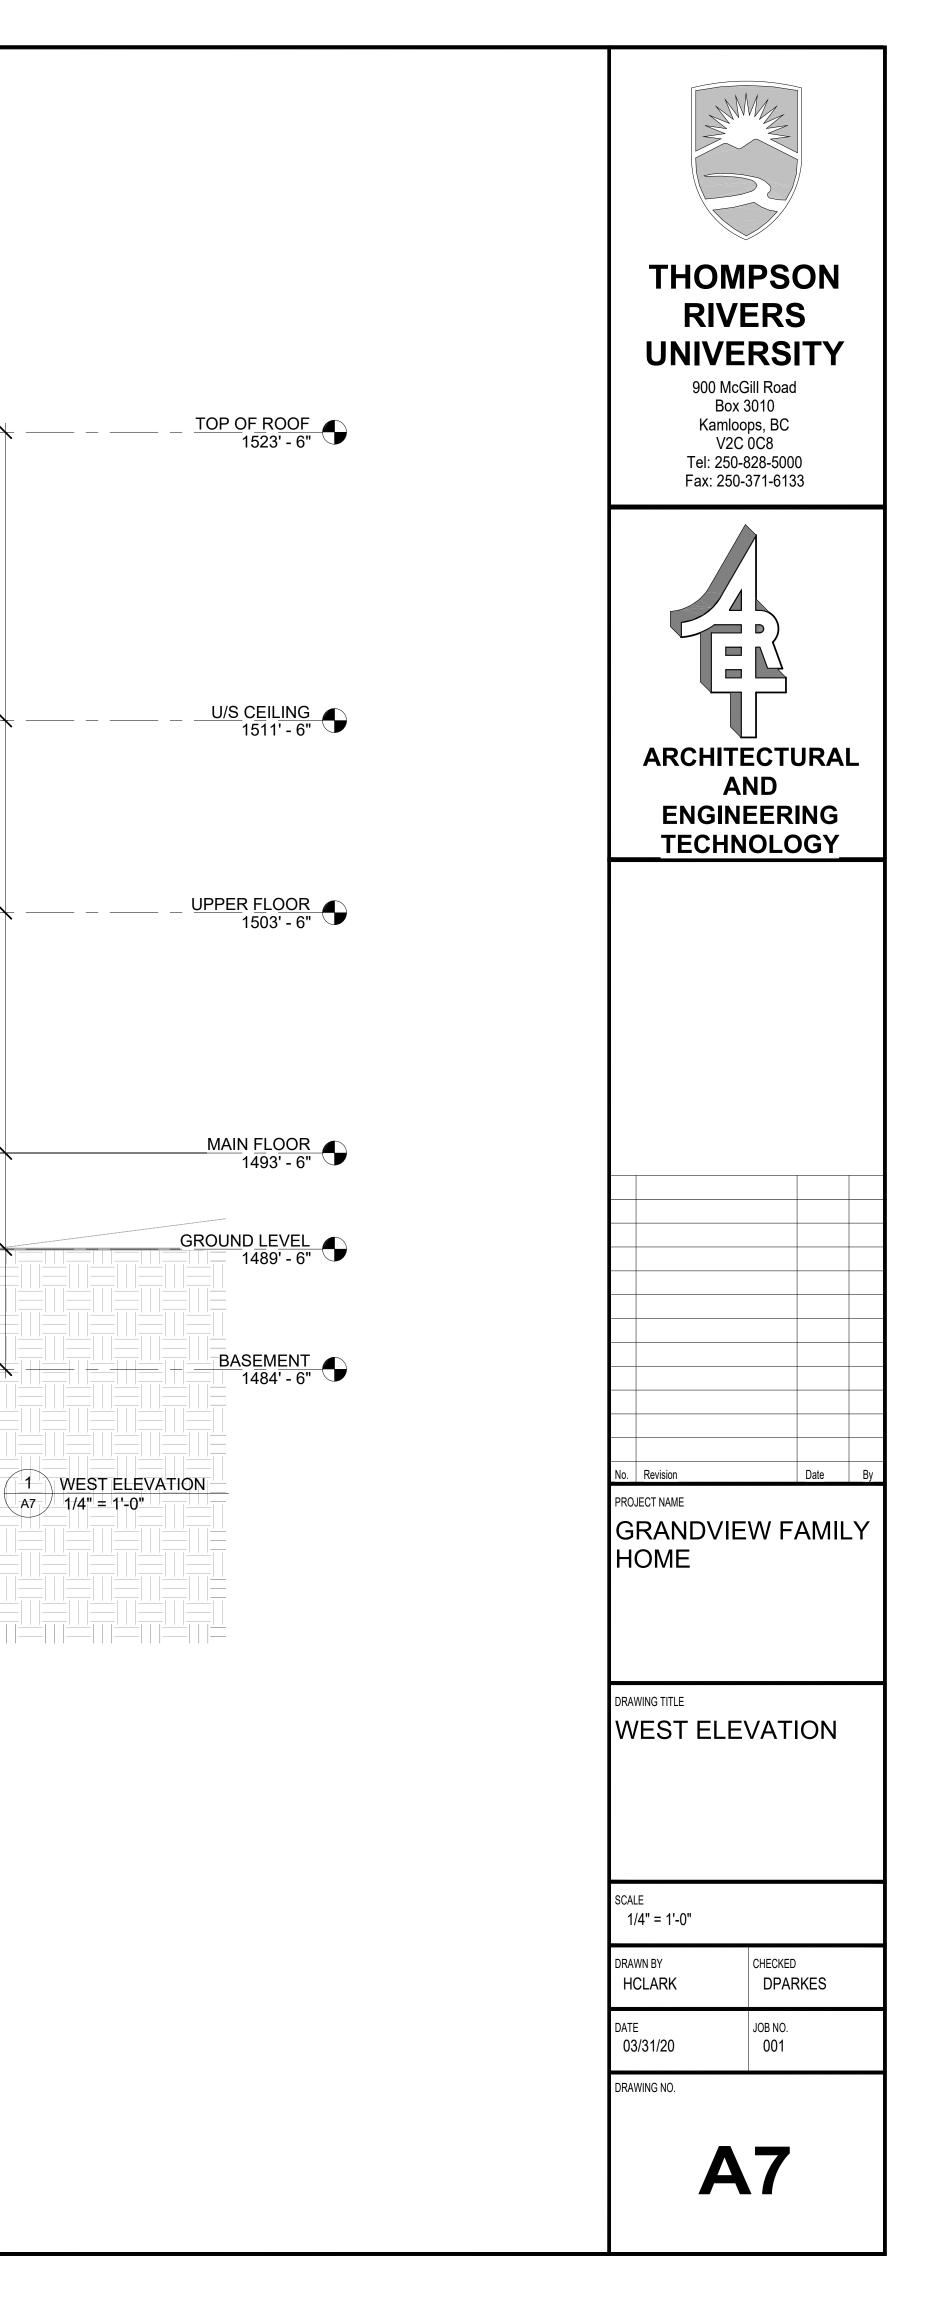

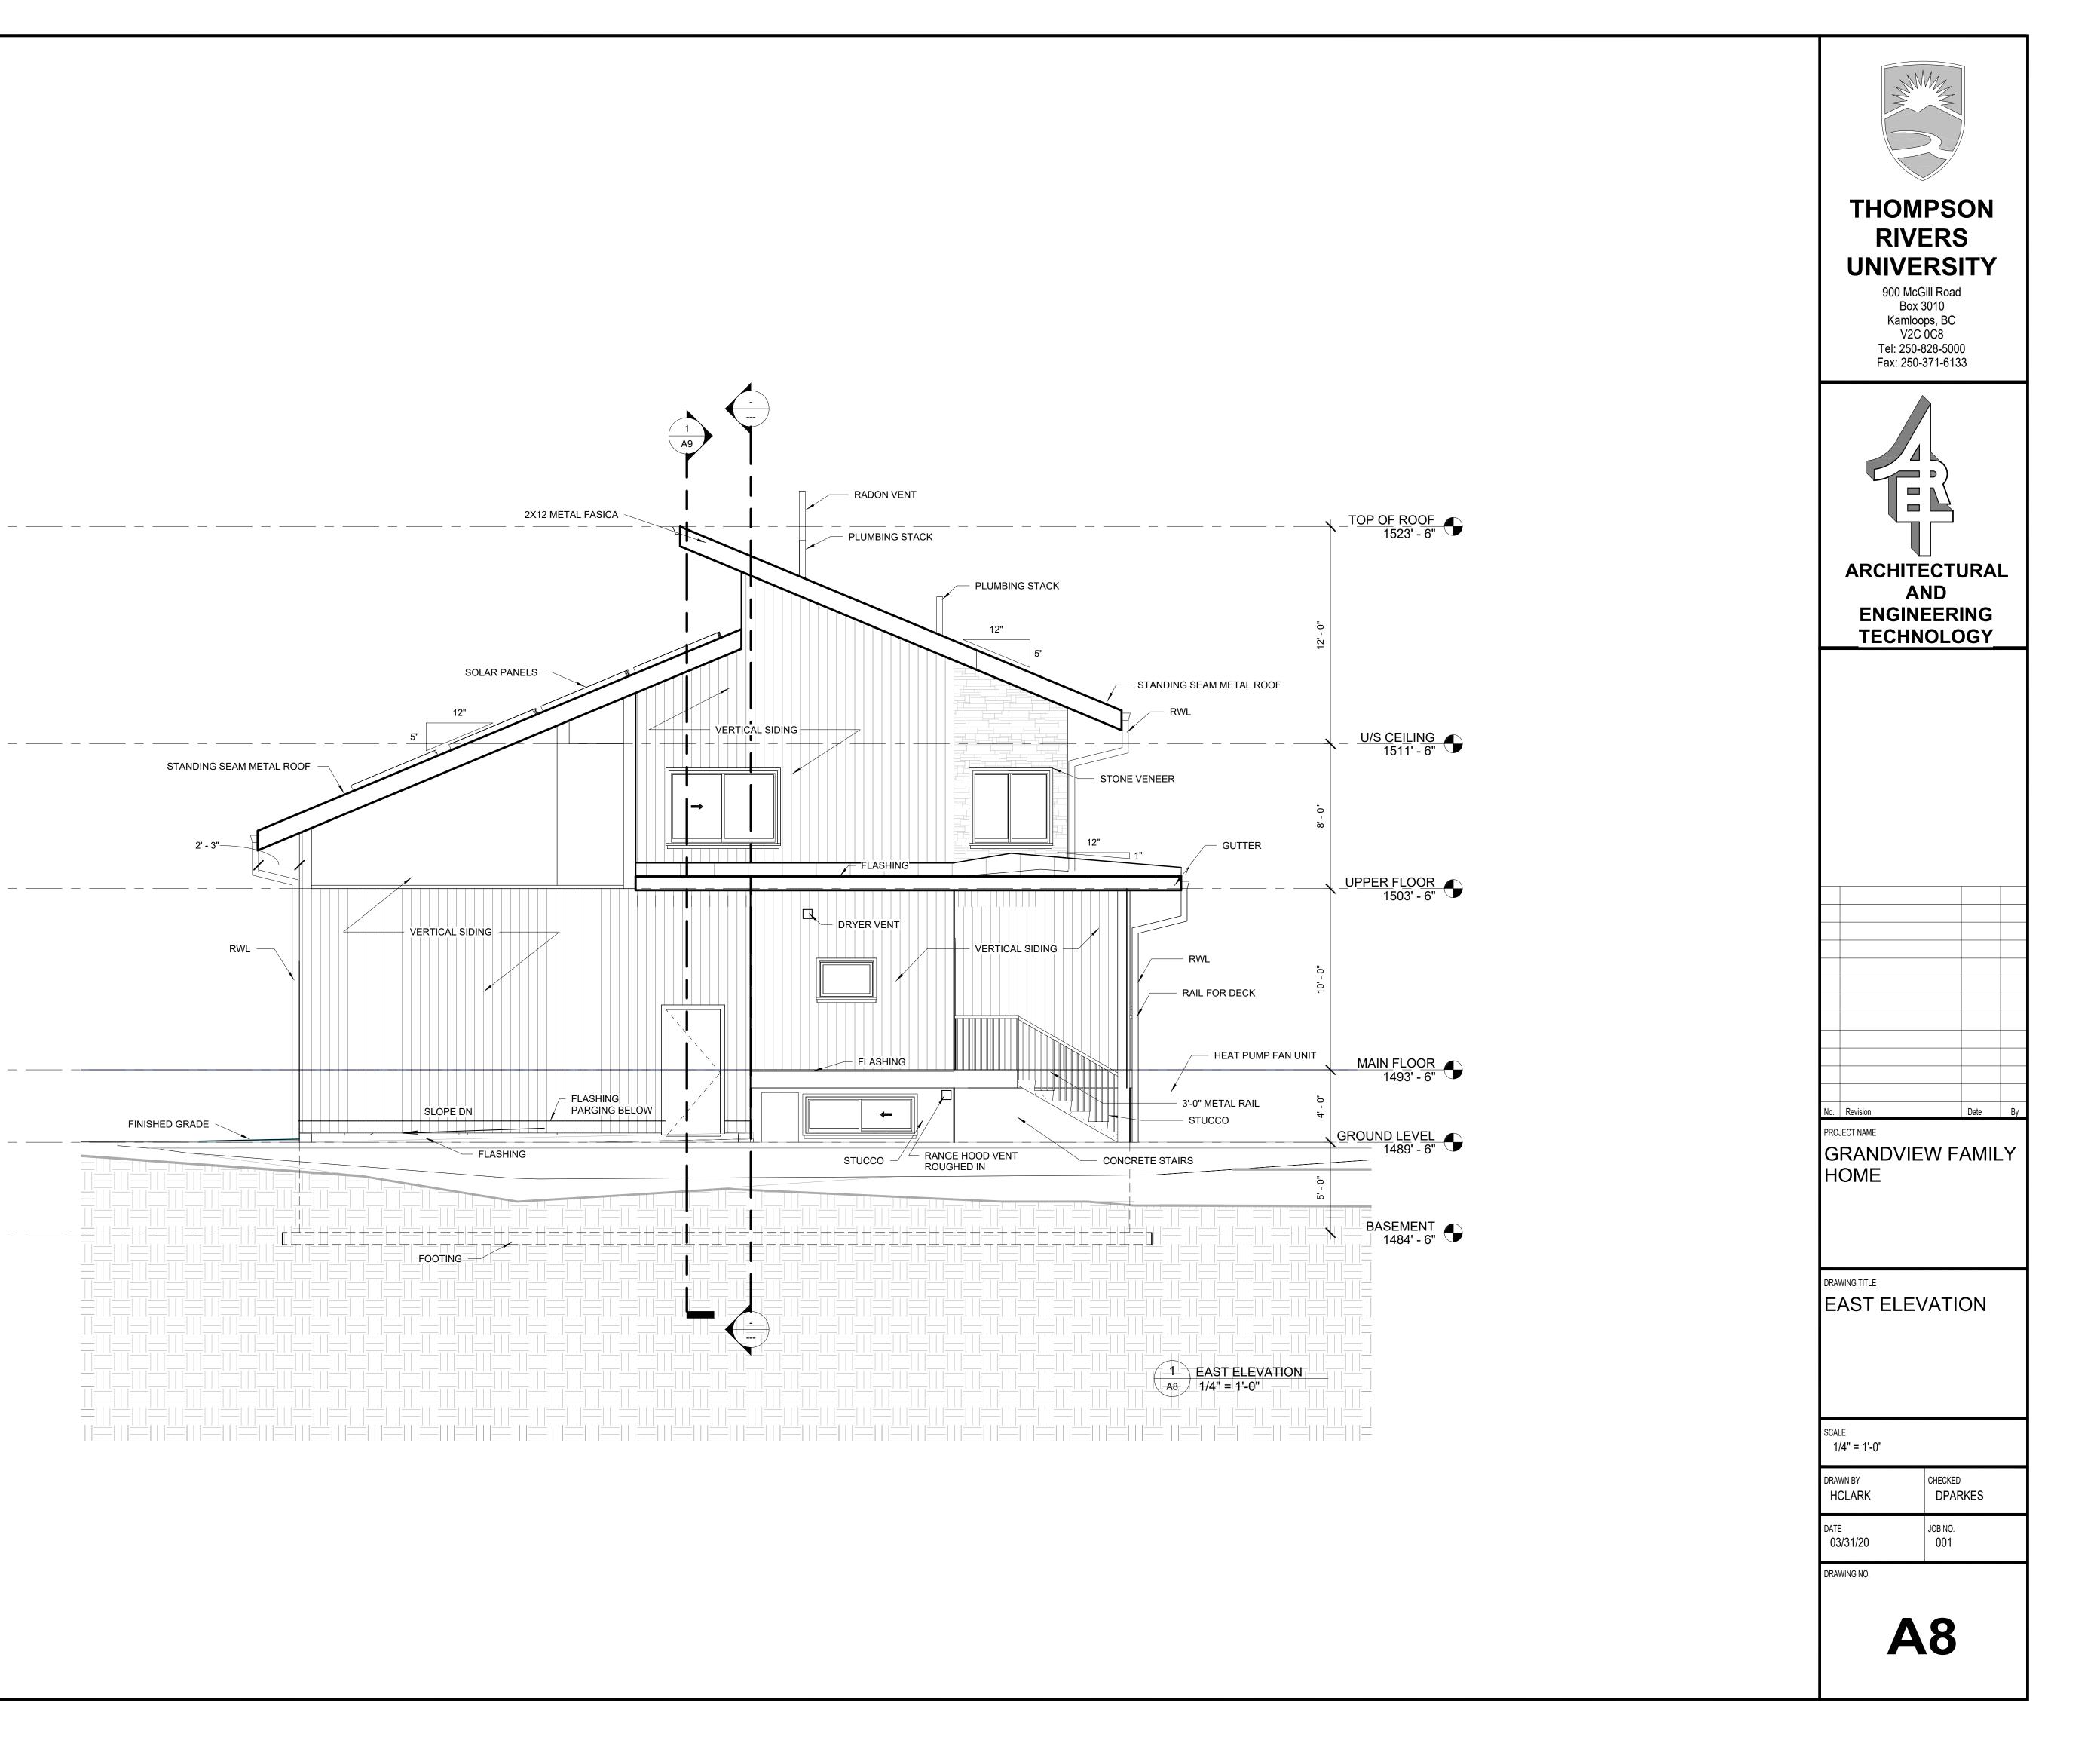

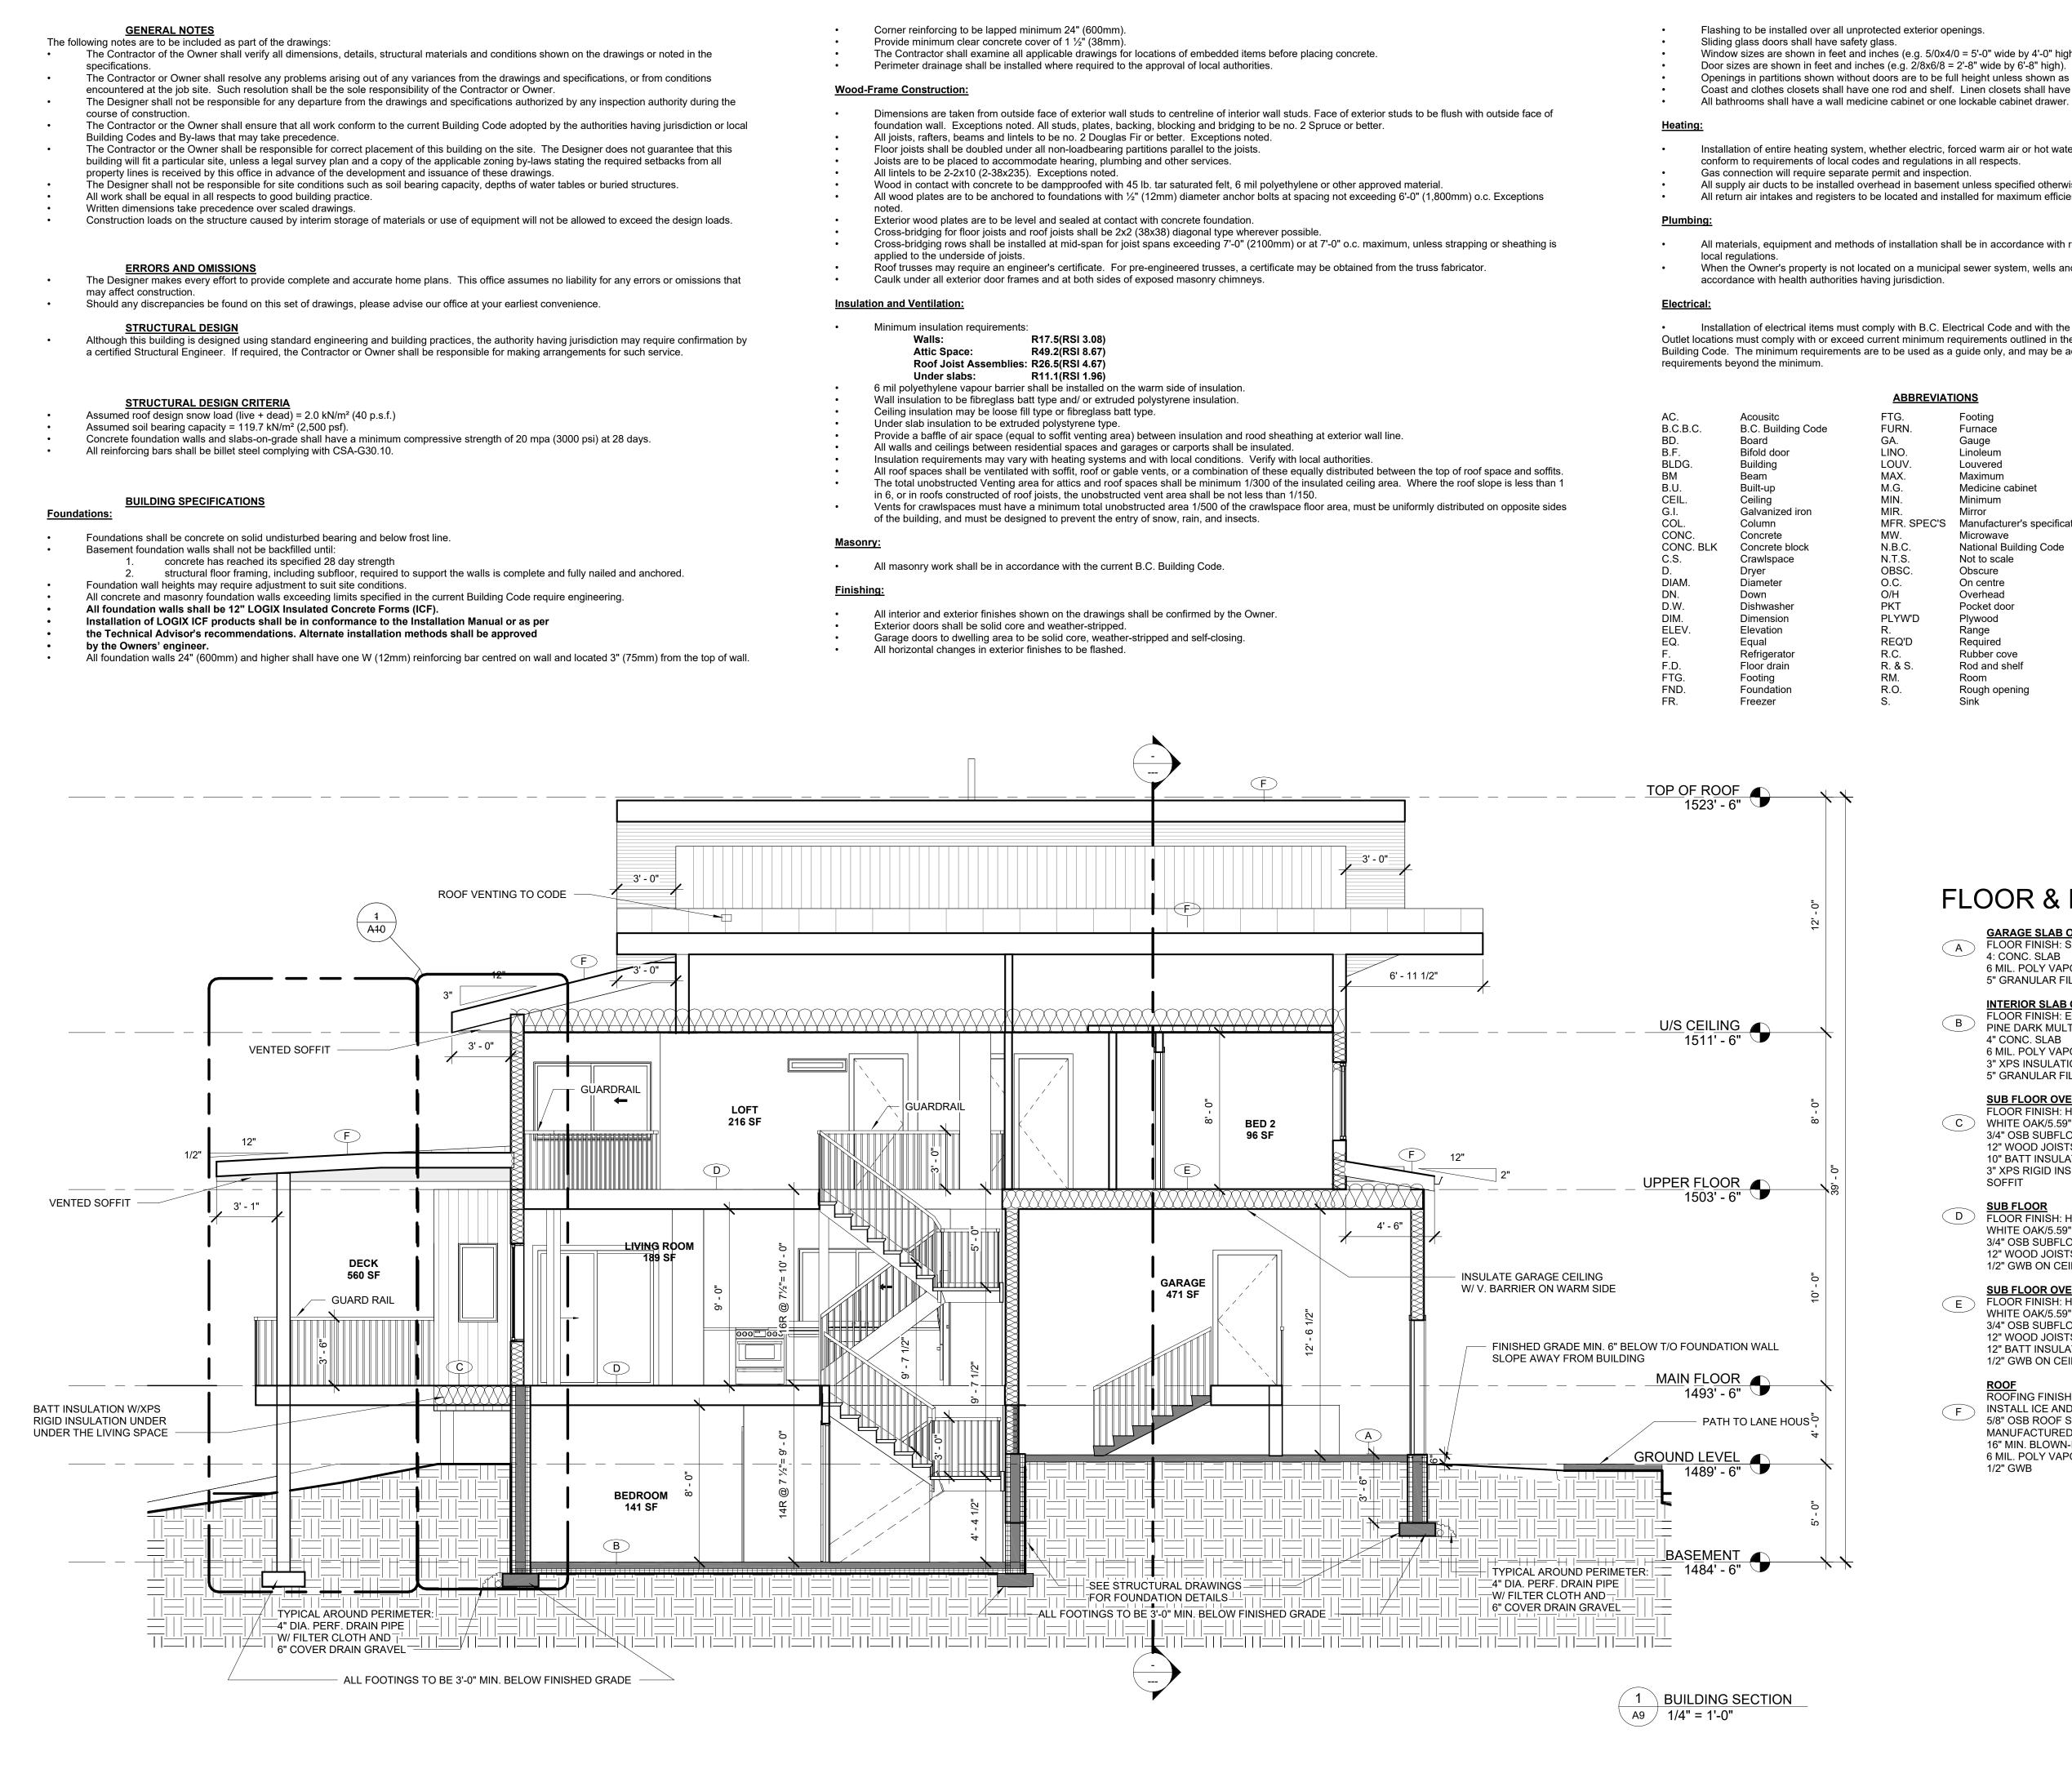

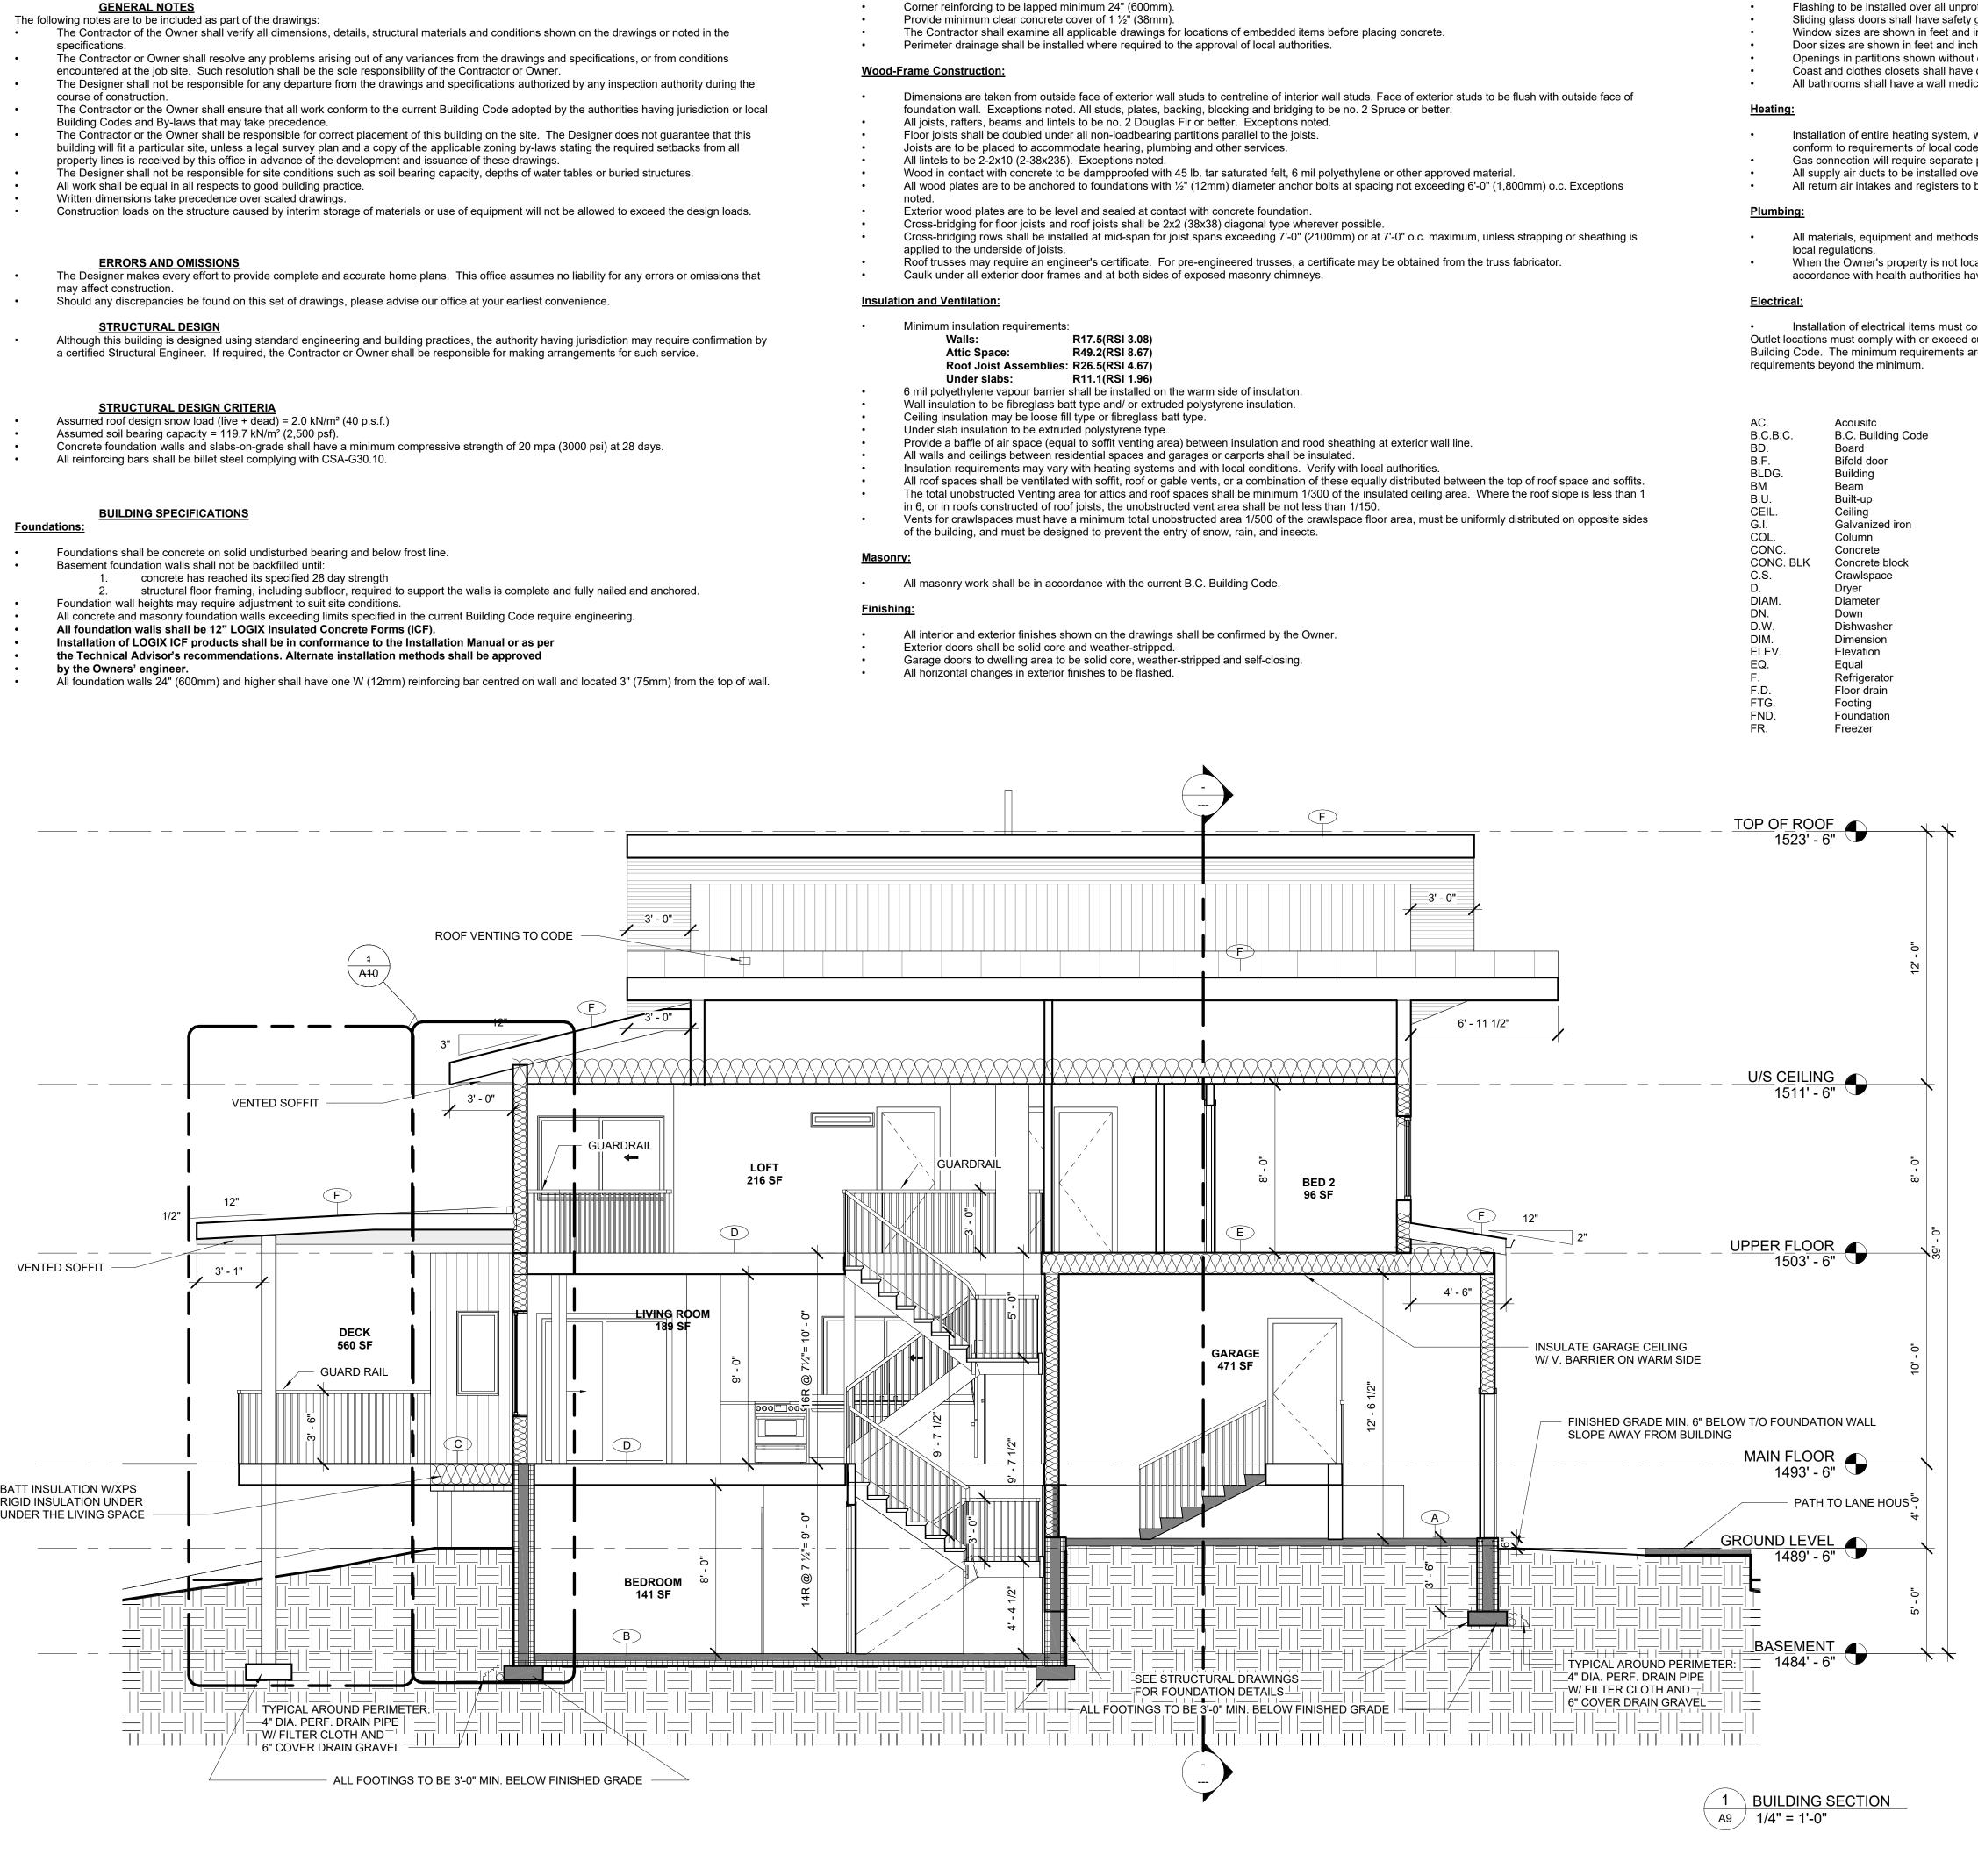

Window sizes are shown in feet and inches (e.g. 5/0x4/0 = 5'-0" wide by 4'-0" high).

Openings in partitions shown without doors are to be full height unless shown as an arch. Lintels at archways to be framed 6'-11" high. Exceptions noted. Coast and clothes closets shall have one rod and shelf. Linen closets shall have 5 adjustable shelves where possible. Broom closets shall have one shelf.

Installation of entire heating system, whether electric, forced warm air or hot water, must comply with manufacturer's directions (where applicable) and All supply air ducts to be installed overhead in basement unless specified otherwise.

All return air intakes and registers to be located and installed for maximum efficiency by a qualified heating contractor.

All materials, equipment and methods of installation shall be in accordance with requirements outlined in Part 7 of the B.C. Building Code and applicable When the Owner's property is not located on a municipal sewer system, wells and septic disposal systems are to be located and constructed in

Installation of electrical items must comply with B.C. Electrical Code and with the local electrical supplier in all respects. Outlet locations must comply with or exceed current minimum requirements outlined in the B.C. Building Code. The minimum requirements outlined in the B.C. Building Code. The minimum requirements are to be used as a guide only, and may be adjusted according to the Owner's and/or local authority's specific

ABBREVIATIONS

FTG.	Footing	SIC
FURN.	Furnace	SH.
GA.	Gauge	SUSP.
LINO.	Linoleum	T/O
LOUV.	Louvered	TYP.
MAX.	Maximum	GYP. BD.
M.G.	Medicine cabinet	H.B.
MIN.	Minimum	HORIZ.
MIR.	Mirror	HT.
MFR. SPEC'S	Manufacturer's specifications	H.W.T.
MW.	Microwave	INSUL.
N.B.C.	National Building Code	L.C.
N.T.S.	Not to scale	LDRY.
OBSC.	Obscure	LIN.
O.C.	On centre	U/S
O/H	Overhead	W.
PKT	Pocket door	W/
PLYW'D	Plywood	W.C.
R.	Range	WD.
REQ'D	Required	W.P.
R.C.	Rubber cove	W.W.M.
R. & S.	Rod and shelf	VERT.
RM.	Room	V.B.
R.O.	Rough opening	
S.	Sink	

Solid core Shower Suspended Top of Typical Gypsum board Hose bib Horizontal Height Hot water tank Insulation Laundry chute Laundry Linen Underside (Clothes) Washer With Water closet Wood Weatherproof Welded wire mesh Vertical Vapour barrier

FLOOR & ROOF SCHEDULE

GARAGE SLAB ON GRADE $\langle \mathsf{A} \rangle$

FLOOR FINISH: SMOOTH CONCRETE 4: CONC. SLAB 6 MIL. POLY VAPOUR BARRIER 5" GRANULAR FILL

INTERIOR SLAB ON GRADE

- FLOOR FINISH: ENGINEERED VINYL PLANKS HARRISON **(B**) ⁾ PINE DARK MULTI-WIDTH X 47.6 INCH LUXURY 4" CONC. SLAB 6 MIL. POLY VAPOUR BARRIER
 - 3" XPS INSULATION (R12) 5" GRANULAR FILL

SUB FLOOR OVER CANTILEVERED DINING ROOM FLOOR FINISH: HAKWOOD "TRANQUILITY"/EUROPEAN C WHITE OAK/5.59" OIL FINISH

3/4" OSB SUBFLOOR 12" WOOD JOISTS **10" BATT INSULATION 3" XPS RIGID INSULATION** SOFFIT

D SUB FLOOR FLOOR FINISH: HAKWOOD "TRANQUILITY"/EUROPEAN WHITE OAK/5.59" OIL FINISH 3/4" OSB SUBFLOOR 12" WOOD JOISTS 1/2" GWB ON CEILING

SUB FLOOR OVER GARAGE FLOOR FINISH: HAKWOOD "TRANQUILITY"/EUROPEAN

WHITE OAK/5.59" OIL FINISH 3/4" OSB SUBFLOOR 12" WOOD JOISTS **12" BATT INSULATION** 1/2" GWB ON CEILING


ROOFING FINISH: STANDING SEAM METAL ROOF - COLOUR: NAVY INSTALL ICE AND WATER SHIELD UNDER EACH PANEL F 5/8" OSB ROOF SHEATHING MANUFACTURED TRUSSES 16" MIN. BLOWN-IN CELLULOSE INSULATION 6 MIL. POLY VAPOUR BARRIER 1/2" GWB



THOMPSON RIVERS UNIVERSITY

900 McGill Road Box 3010 Kamloops, BC V2C 0C8 Tel: 250-828-5000 Fax: 250-371-6133



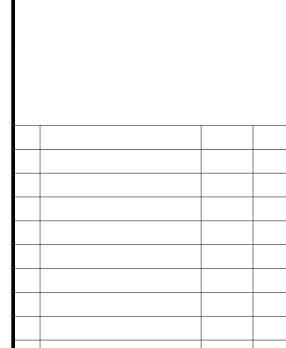

Date b. Revision PROJECT NAME **GRANDVIEW FAMILY** HOME

DRAWING TITLE

BUILDING SECTION

SCALE

1/4" = 1'-0"

CHECKED DRAWN BY HCLARK DPARKES

JOB NO.

001

04/06/20

DRAWING NO.



